
Simulations
Photos
All Graphics (no plans)




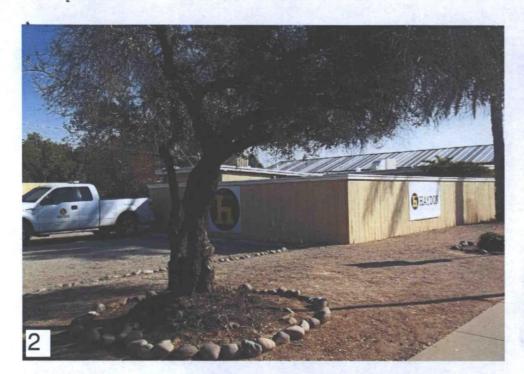







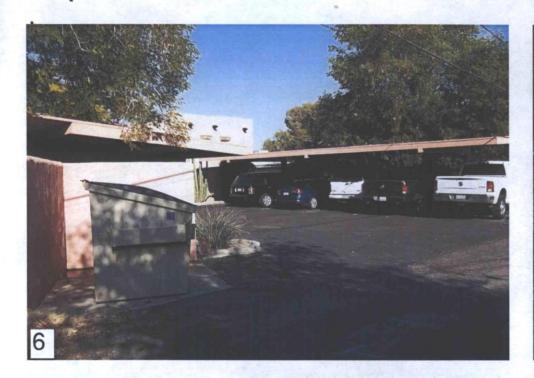










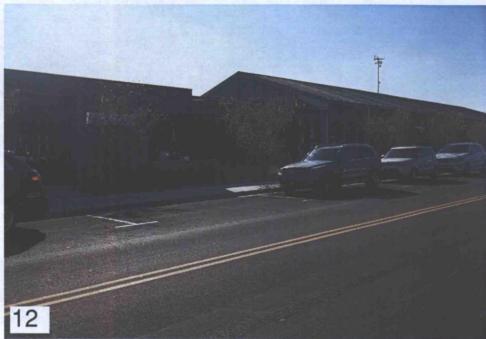












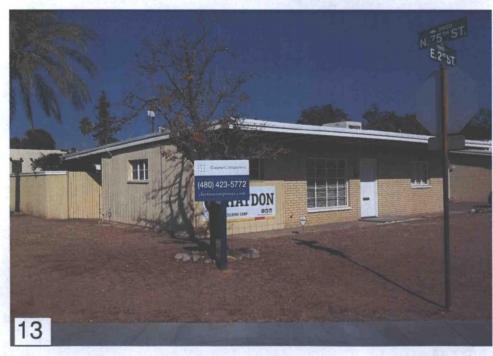

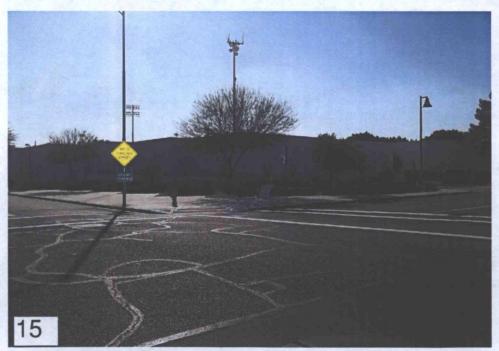


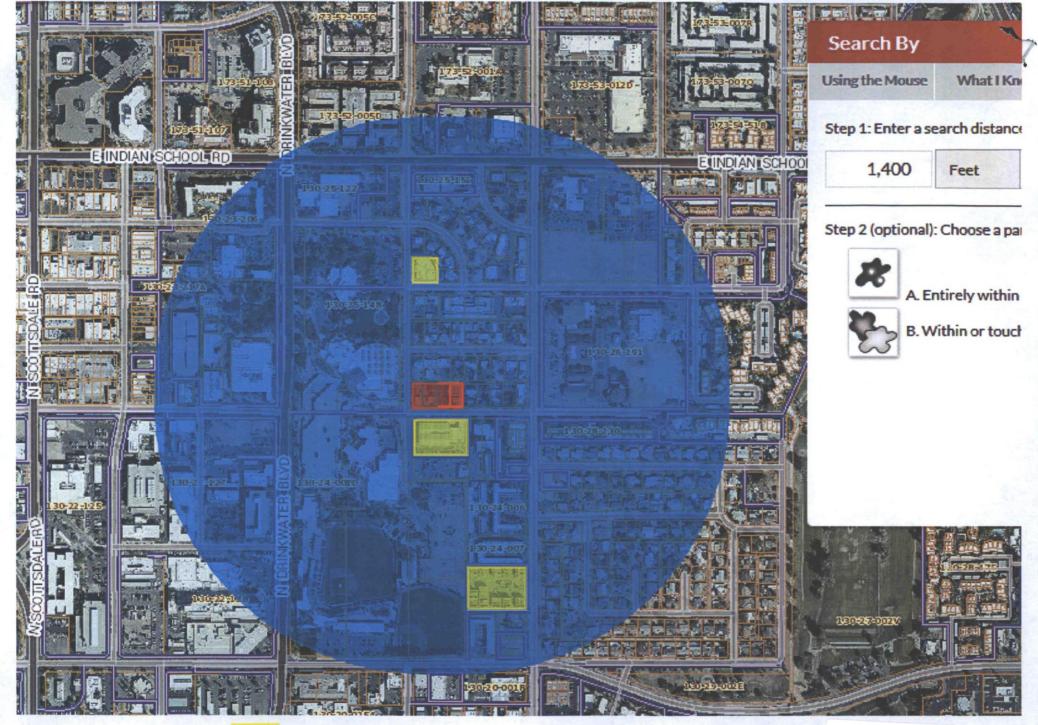


Newly Developed Properties within 1/4 mile



Main Street Plaza - 7502 E. Main St.

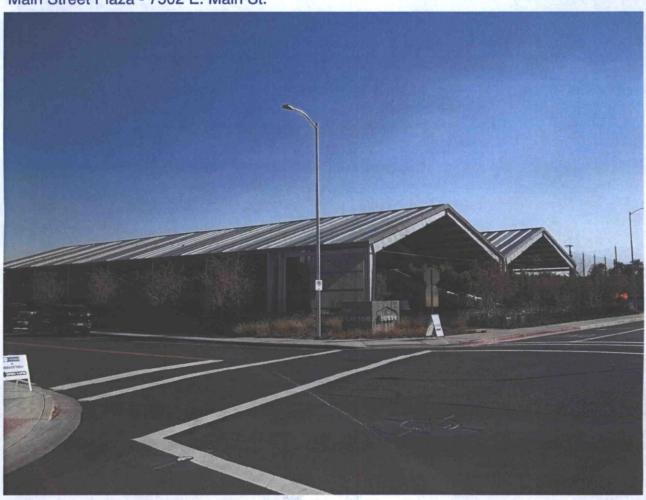

The CLAYTON House - 3719 N 75th St

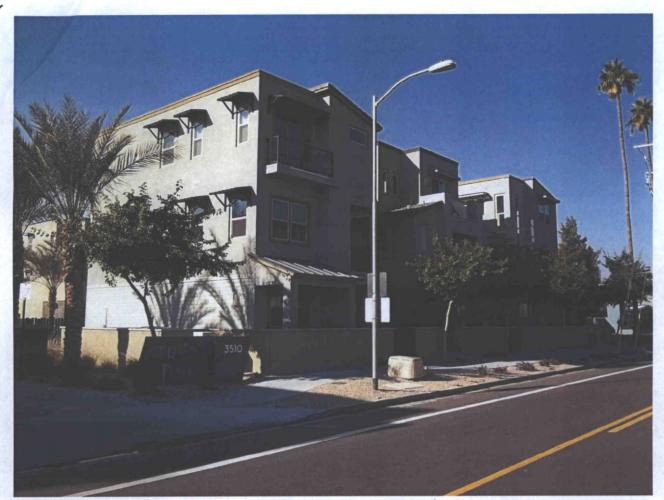

Treo - 3510 N. Miller Rd.



1 Site Plan - Boundary 1" = 20'-0"

> 2-ZN-2019 2/14/19

K & I HOMES, LLC



::: Clayton

75 on 2nd

Revisions Description


OWNERSHIP OF


DILAMINISMA AND INFOCINCATIONS INSTITUTED AND INFOCINCIA AND IN SHALL REMAINS THE PRODUCTION OF ANO-HIGH TO WHITE HIS PROPOSED FOR WHITE OF MACHINITY OF THE PRODUCTION OF MOY, THAT AND INCOME TO THE WINDLESS OF THE WINDLES


JOB NUMBER: 1809 DRAWN BY: Author CHECKED BY: Checker ISSUE DATE: 01/31/2018



A0.3

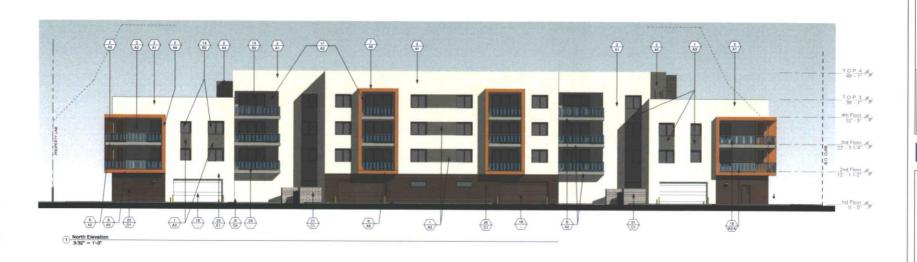

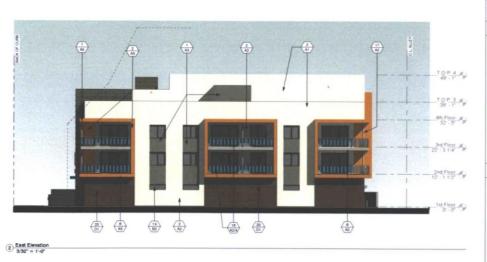

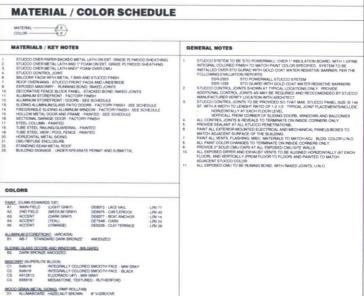

METAL ROOF PANELS (MORIN OR EQ.) E1. CUSTOM COLOR TO MATCH PAINT AS

K & I HOMES, LLC E INDIAN SCHO SUITE 2006 TITSDALE, AZ 81 H: 602-505-252

::: Clayton

7502 East 2nd Street Scottsdale, AZ 75 on 2nd

Revisions # Description Date

OWNERSHIP OF DOCUMENTS

DOCUMENTS

DOCUMENTS

DISAMPAGE AND PROPRISTORS AS
118TH AMERITS OF SERVICE ARE AND
118TH AMERITS OF SERVICE ARE AND
118TH AMERITS OF SERVICE ARE
118TH AMERITS OF SERVICE AND
118TH AMERICAN
118TH AMER

DRAWN BY: KS CHECKED BY: KS

SSUE DATE: 01/31/2019


SHEET TITLE:
Exterior Elevations

SHEET NUMBER

A3.2

ReZone - Design Review



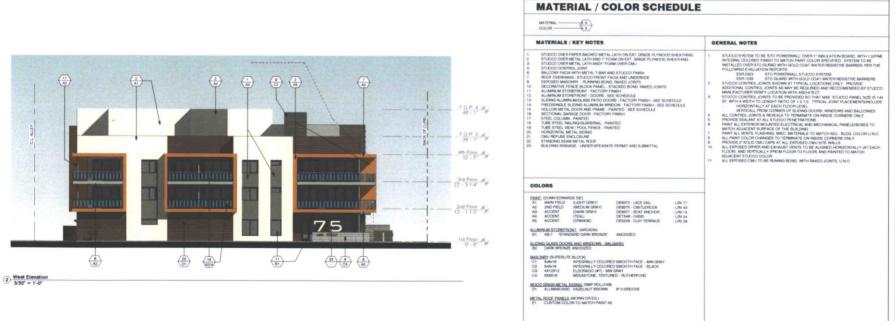

2/4/2019 8:55:20 AM

K & I HOMES, LLC NDIAN SCHOOL P SUITE 2006 TSDALE, AZ 85251



::: Clayton

7502 East 2nd Street Scottsdale, AZ 75 on 2nd

Revisions # Description Date

OWNERSHIP OF DOCUMENTS

DALUGINENTS

DIRAUVISIA SALD PROPORTIONIS AS ASSEMBLANCING OF SERVICE ARE ASSEMBLANCING ARE ASSEMBLANCING OF SERVICE ASSEMBLANCING OF SERVICE ASSEMBLANCING OF SERVICE ASSEMBLANCING OF SERVICE OF SER

DRAWN BY: Author

CHECKED BY: Checker ISSUE DATE: 01/31/2019




Exterior Elevations

SHEET NUMBER:

A3.1



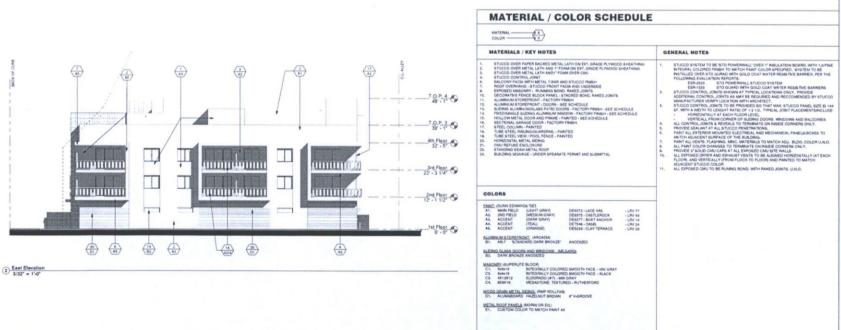

K & I HOMES, LLC

::: Clayton

75 on 2nd

Revision

Description Date

OWNERSHIP OF DOCUMENTS

DINAMES AND DIVENTAGE AND THE AND THE

JOB NUMBER: 1809 DRAWN BY: KS CHECKED BY: KS

ISSUE DATE: 01/31/2019



Exterior Elevations

SHEET NUMBER

A3.2

2-ZN-2019 2/14/19 K & I HOMES, LLC



::: Clayton

75 on 2nd

Revisions
Description Date

OWNERSHIP OF DOCUMENTS
DOCUMENTS
DRAWINGS AND SECURITY AS A SECURITY OF SECURITY AND ASSAULT AND ASSAULT AND ASSAULT AND ASSAULT AND ASSAULT AND ASSAULT ASSAU

JOB NUMBER: 1808 DRAWN BY: Author CHECKED BY: Checker ISSUE DATE: 01/51/2019



Exterior Elevat

SHEET NUMBER:

A3.1



PERSPECTIVE VIEW FROM SOUTHEAST

K & I HOMES, LLC



::: Clayton

7502 East 2nd Street Scottsdale, AZ 75 on 2nd

Revisions
Description Date



A5

ReZone - Design Review

Arghii A1 A2.1 A2.2 A2.3 A2.4 A2.5 A3 A4 A5

APPLICANT / ARCHITECT

2 3D View - from SW 12" = 1'-0"

SCOTTSDALE, AZ 85251 602-505-2525 KRISTJAN SIGURDSSON

7340 E MAIN ST #200 SCOTTSDALE, AZ 85251 480-941-2260 MAX FRENKEL

OWNER / DEVELOPER

K & I HOMES, LLC



::: Clayton

7502 East 2nd Street Scottsdale, AZ 75 on 2nd

Description Date


DRAWN BY: KS CHECKED BY: KS ISSUE DATE: 01/31/201



SHEET TITLE: Cover Sheet

A0.1



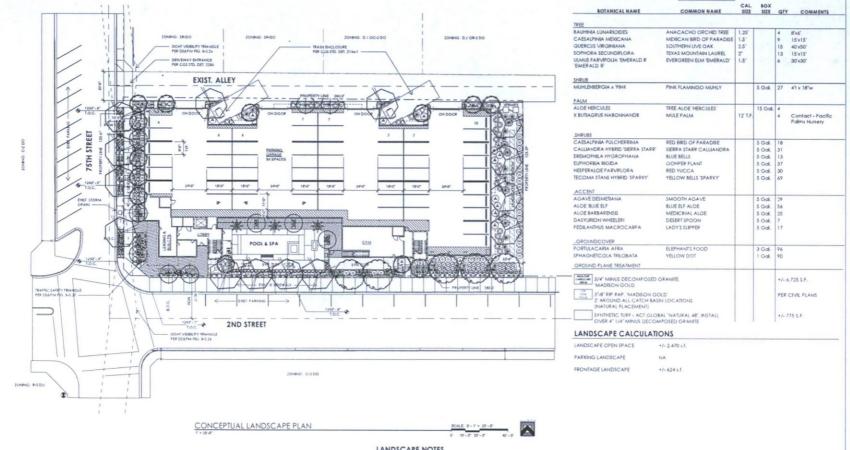


LANDSCAPE NOTES

- 1. DECOMPOSED GRANITE OR SIMILAR MATERIAL AROUND THE MATURE FORM OF A SPECIMEN PLANT, TREE CANOPY, OR GROUPS OF PLANTS, SHALL NOT EXCEED SEVEN (7) FEET IN ANY DIRECTION, PER ZONING ORDINANCE SECTION 10.501.A.
- ALL TREES SHALL BE FIFTEEN (15) GALLON MINIMUM SIZE, AND A LEAST FIFTY (SO) PERCENT SHALL BE MATURE TREES WITH A MINIMUM 2" CALIPER.
- 3. THIS PROJECT CONTAINS NO NEW PARKING / LANDSCAPE AREAS & REQUIREMENTS.
- 4. ALL PLANT MATERIALS SHALL BE FROM THE ARIZONA DEPARTMENT OF WATER RESOURCE'S (ADWR) PHOENIX ACTIVE MANAGEMENT AREA PLANT LIST & IS EXEMPT FROM THE CITY OF SCOTTSDALE'S ENVIRONMENTALLY SENSITIVE LANDS ORDINANCE (ESLO) PLANT LIST.
- 5. THIS PROJECT DOES NOT CONTAIN ANY NATURAL AREA OPEN SPACE (NAOS).
- 6. NO NATIVE PLANT INVENTORY & SALVAGE REQUIRED FOR THIS LOCATION.
- THORNY SHRUBS AND CACTI SHALL BE PLANTED SO THAT THEIR MATURE SIZE/CANOPY WILL BE AT LEAST 4 FEET AWAY FROM ANY WALKWAYS OR PARKING AREA CURBING, PER DSPM SEC. 2-1.1001,13.
- 8. ALL SIDEWALKS TO BE A MIN. 6'-0" CLEAR.
- 9. ALL FIRELANE SURFACES SHALL SUPPORT 83,000 LBS GROSS VEHICULAR WEIGHT PER DS & PM 2-1.802(3)

10.ALL LANDSCAPE AREAS SHALL BE IRRIGATED BY AUTOMATIC UNDERGROUND IRRIGATION SYSTEM.

11. REFER TO CIVIL FOR ALL GRADING, DRAINAGE, RETENTION AREAS, SETBACKS, EASEMENTS & P.U.E. LOCATIONS

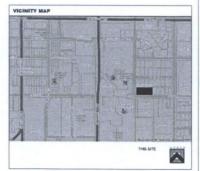

PLANT LEGEND

K & I HOMES, LLC



::: Clayton

iPIXELstudi

2nd Street East 2nd S On 75

Description Date

DOCUMENTS


DRAWN BY: DSS CHECKED BY: DIS





Landscape Plan





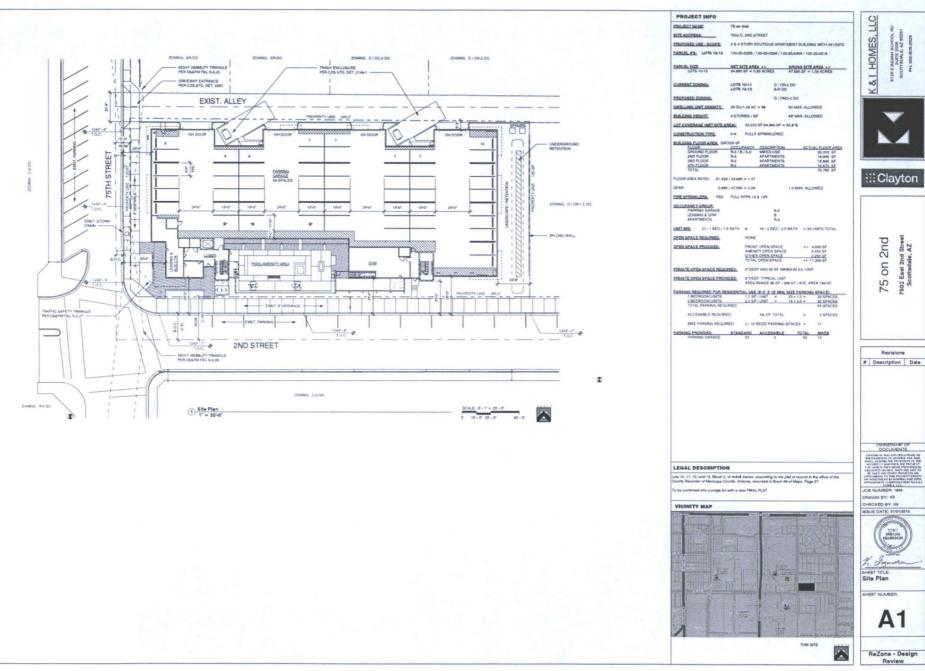

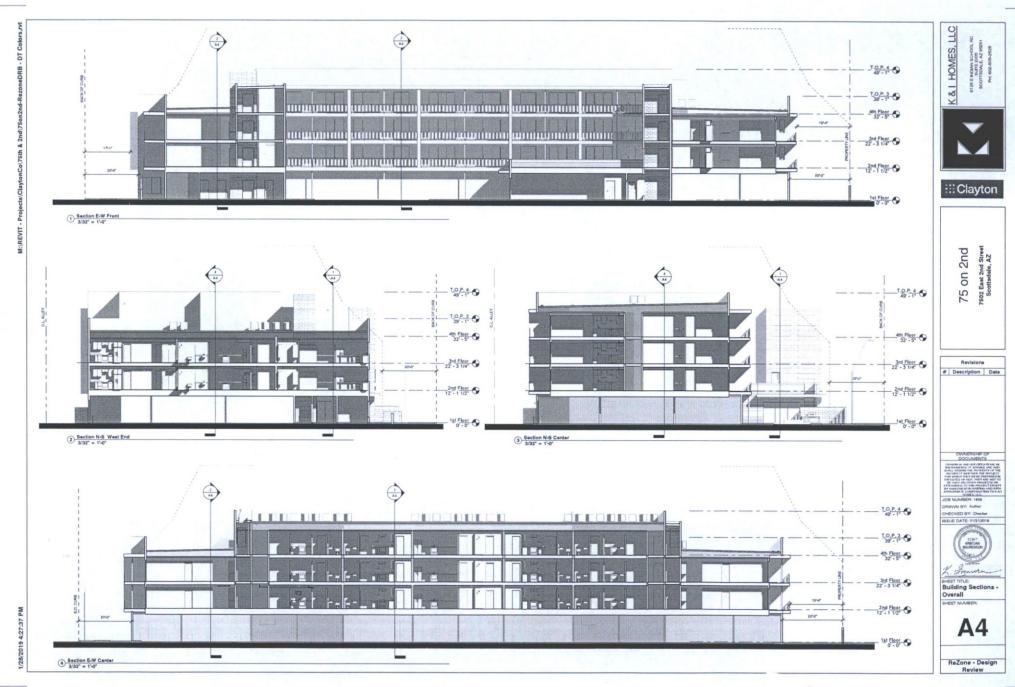

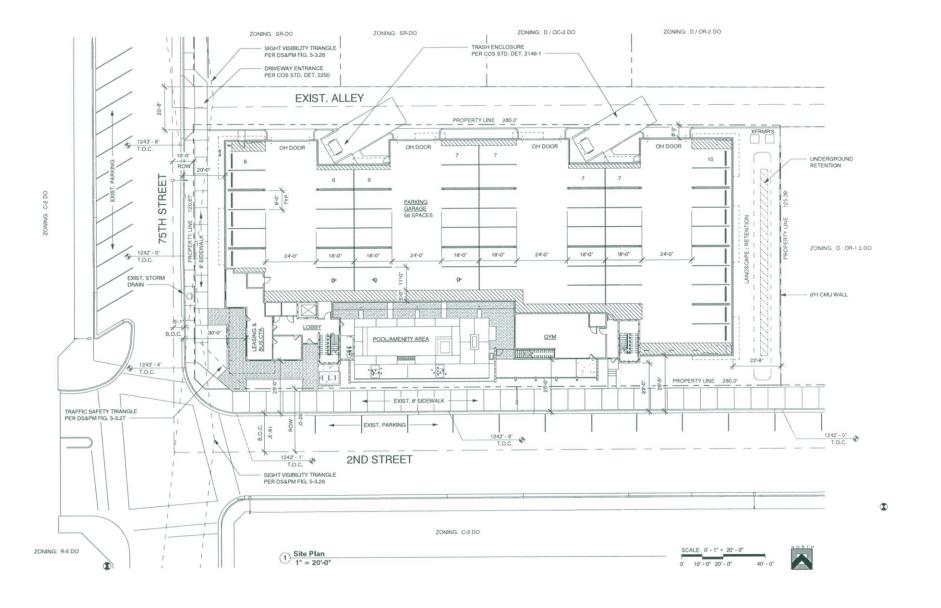

PROJECT INFO PROJECT NAME: 75 on 2nd SITE ADDRESS: 7502 E. 2ND STREET PROPOSED USE / SCOPE: 3 & 4 STORY BOUTIQUE APARTMENT BUILDING WITH 39 UNITS PARCEL #S: LOTS 10-13 130-25-028B / 130-25-029A / 130-25-030A / 130-25-031A NET SITE AREA +/34,980 SF = 0.80 ACRES
47,560 SF = 1.09 ACRES D / OR-2 DO S-R DO CURRENT ZONING: LOTS 10-11 LOTS 12-13 D / DMU-2 DO PROPOSED ZONING: DWELLING UNIT DENSITY: 39 DU/1.09 AC = 36 50 MAX. ALLOWED BUILDING HEIGHT: 4 STORIES / 50' 66' MAX. ALLOWED LOT COVERAGE (NET SITE AREA): 20.002 SF/34,980 SF = 62.9 % CONSTRUCTION TYPE: V-A FULLY SPRINKLERED BUILDING FLOOR AREA: GROSS SF FLOOR GROUND FLOOR 2ND FLOOR 3RD FLOOR 4TH FLOOR TOTAL | OCCUPANCY | DESCRIPTION | R-2 / B / S-2 | MIXED-USE | APARTMENTS | R-2 | APARTMENTS | R-2 | APARTMENTS | AP 20,002 SF 18,945 SF 18,945 SF FLOOR AREA RATIO: 51,429 / 34,980 = 1.47 GFAR: 2,666 / 47,560 = 0.06 1.3 MAX. ALLOWED FIRE SPRINKLERS: YES FULL NFPA 13 & 13R OCCUPANCY GROUP: LEASING & GYM APARTMENTS UNIT MIX: 23 - 1 BED / 1.5 BATH & 16 - 2 BED / 2.5 BATH = 39 UNITS TOTAL OPEN SPACE REQURIED:

FRONT OPEN SPACE AMENITY OPEN SPACE

4% OF TOTAL

PRIVATE OPEN SPACE REQURIED: 6' DEEP AND 60 SF MINIMUM EA. UNIT PRIVATE OPEN SPACE PROVIDED: 8' DEEP TYPICAL UNIT AREA RANGE 9S SF - 296 SF / AVE. AREA 189 SF

BIKE PARKING REQUIRED: 2 / 10 REQ'D PARKING SPACES = 11 PARKING PROVIDED: STANDARD ACCESSIBLE TOTAL BIKES
PARKING GARAGE 53 3 56 12

Lots 10, 11, 12, and 13, Block 2, of redell manor, according to the plat of record in the office of the County Recorder of Maricopa County, Arizona, recorded in Book 49 of Maps, Page 27

To be combined into a single lot with a new FINAL PLAT

LEGAL DESCRIPTION

VICINITY MAP

OPEN SPACE PROVIDED:

ACCESSIBLE REQUIRED:





K & I HOMES, LLC INDIAN SCHO SUITE 2005 TSDALE, AZ 8



::: Clayton

on 2nd Street AZ East 2nd S 75 7502 E

Description Date

OWNERSHIP OF DOCUMENTS


DRAWINGS AND SPECIFICATIONS AS DEVAL, REMAIN THE PROPERTY OF THE ADDRESS OF THE PROJECT OF THE ADDRESS OF THE PROJECT OF THE PROJECT

DRAWN BY: KS CHECKED BY: KS SUE DATE: 01/31/



2-ZN-2019 2/14/19

SHEET NUMBER:

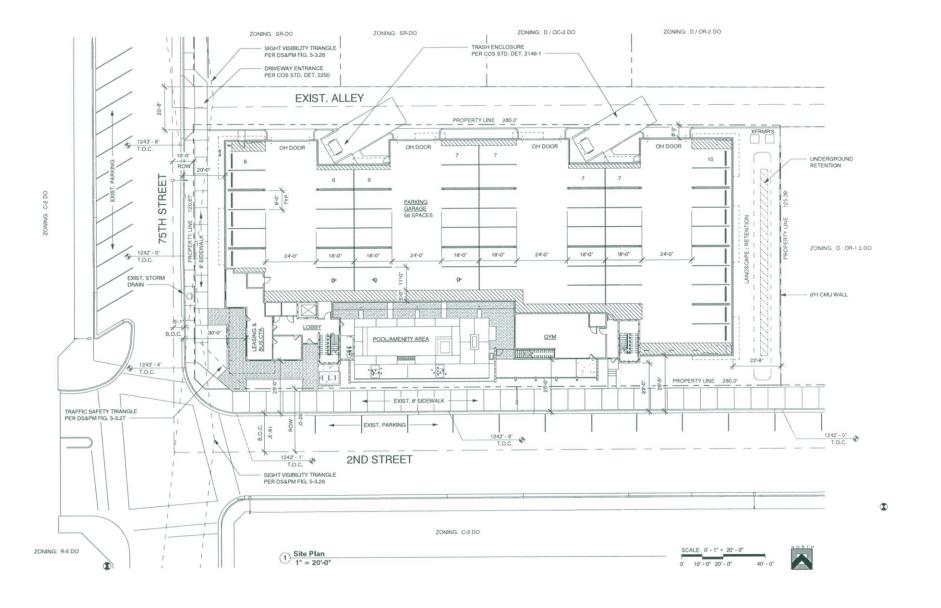

PROJECT INFO PROJECT NAME: 75 on 2nd SITE ADDRESS: 7502 E. 2ND STREET PROPOSED USE / SCOPE: 3 & 4 STORY BOUTIQUE APARTMENT BUILDING WITH 39 UNITS PARCEL #S: LOTS 10-13 130-25-028B / 130-25-029A / 130-25-030A / 130-25-031A NET SITE AREA +/34,980 SF = 0.80 ACRES
47,560 SF = 1.09 ACRES D / OR-2 DO S-R DO CURRENT ZONING: LOTS 10-11 LOTS 12-13 D / DMU-2 DO PROPOSED ZONING: DWELLING UNIT DENSITY: 39 DU/1.09 AC = 36 50 MAX. ALLOWED BUILDING HEIGHT: 4 STORIES / 50' 66' MAX. ALLOWED LOT COVERAGE (NET SITE AREA): 20.002 SF/34,980 SF = 62.9 % CONSTRUCTION TYPE: V-A FULLY SPRINKLERED BUILDING FLOOR AREA: GROSS SF FLOOR GROUND FLOOR 2ND FLOOR 3RD FLOOR 4TH FLOOR TOTAL | OCCUPANCY | DESCRIPTION | R-2 / B / S-2 | MIXED-USE | APARTMENTS | R-2 | APARTMENTS | R-2 | APARTMENTS | AP 20,002 SF 18,945 SF 18,945 SF FLOOR AREA RATIO: 51,429 / 34,980 = 1.47 GFAR: 2,666 / 47,560 = 0.06 1.3 MAX. ALLOWED FIRE SPRINKLERS: YES FULL NFPA 13 & 13R OCCUPANCY GROUP: LEASING & GYM APARTMENTS UNIT MIX: 23 - 1 BED / 1.5 BATH & 16 - 2 BED / 2.5 BATH = 39 UNITS TOTAL OPEN SPACE REQURIED:

FRONT OPEN SPACE AMENITY OPEN SPACE

4% OF TOTAL

PRIVATE OPEN SPACE REQURIED: 6' DEEP AND 60 SF MINIMUM EA. UNIT PRIVATE OPEN SPACE PROVIDED: 8' DEEP TYPICAL UNIT AREA RANGE 9S SF - 296 SF / AVE. AREA 189 SF

BIKE PARKING REQUIRED: 2 / 10 REQ'D PARKING SPACES = 11 PARKING PROVIDED: STANDARD ACCESSIBLE TOTAL BIKES
PARKING GARAGE 53 3 56 12

Lots 10, 11, 12, and 13, Block 2, of redell manor, according to the plat of record in the office of the County Recorder of Maricopa County, Arizona, recorded in Book 49 of Maps, Page 27

To be combined into a single lot with a new FINAL PLAT

LEGAL DESCRIPTION

VICINITY MAP

OPEN SPACE PROVIDED:

ACCESSIBLE REQUIRED:





K & I HOMES, LLC INDIAN SCHO SUITE 2005 TSDALE, AZ 8



::: Clayton

on 2nd Street AZ East 2nd S 75 7502 E

Description Date

OWNERSHIP OF DOCUMENTS

DRAWINGS AND SPECIFICATIONS AS DEVAL, REMAIN THE PROPERTY OF THE ADDRESS OF THE PROJECT OF THE ADDRESS OF THE PROJECT OF THE PROJECT

DRAWN BY: KS CHECKED BY: KS SUE DATE: 01/31/



2-ZN-2019 2/14/19

SHEET NUMBER:



K & I HOMES, LLC

::: Clayton

75 on 2nd

Description Date

SHEET TITLE: Context Aerial

A0.2

2-ZN-2019 2114119

OWNER / DEVELOPER

7340 E. MAIN ST. #200

480-941-2260 MAX FRENKEL

SCOTTSDALE, AZ 85251



A2.1 A2.2 A2.3 A2.4 A2.5 A3 A3 A4 A5

APPLICANT / ARCHITECT

K&I HOMES, LLC

6125 E Indian School Rd #2005

SCOTTSDALE, AZ 85251

602-505-2525 KRISTJAN SIGURDSSON

K & I HOMES, LLC

6125 E INDIAN SCHOOL RD SUITE 2005 SCOTTSDALE, AZ 85251



::: Clayton

7502 East 2nd Street Scottsdale, AZ 75 on 2nd

Description Date

OWNERSHIP OF DOCUMENTS

DRAWN BY: KS

CHECKED BY: KS ISSUE DATE: 01/31/2019



SHEET TITLE:
Cover Sheet

SHEET NUMBER:

A0.1

ReZone - Design Review



2/6/2019 11:00:25 AM





K & I HOMES, LLC

6125 E INDIAN SCHOOL RD

SUMTE 2006
SCOTTSDALE, AZ 85251



::: Clayton

75 on 2nd 7502 East 2nd Street Scottsdale, AZ

Revisions

OWNERSHIP (

DRAWING AND SPECIFICATIONS AN INSTRUMENTS OF SERVICIE ARE AN SHALL REMAIN THE PROPERTY OF THE ARCHITECT WHETHER THE PROJECT OF WHICH THEY WERE PREPARED EXECUTED OR NOT THEY ARE NOT BE USED ON OTHER PROJECTS OF EXTENSIONS TO THIS PROJECT EXC.

BY AGREEMENT IN WRITING APPROPRIATE COMPENSATIO HOMES, LLC. JOB NUMBER: 1809 DRAWN BY: KS CHECKED BY: KS



SHEET TITLE:
Context Aerial

SHEET NUMBE

A0.2

Site Plan - Boundary 1" = 20'-0"

> 2-ZN-2019 2/14/19



::: Clayton

75 on 2nd

Revisions

Description Date

escription

DRAWN BY: Author

CHECKED BY: Checker ISSUE DATE: 01/31/2019



SHEET TITLE:
Boundary Plan

SHEET NUMBER:

A0.3

2-ZN-2019 2/14/19 K & I HOMES, LLC

6128 EINDIAN SCHOOL FID SUTTE 2005 SCOTTSDALE, AZ 85251 PH. 602-505-2525



:::Clayton

75 on 2nd

Revisions

Description Date

OWNERSHIP OF DOCUMENTS

JOB NUMBER: 1809
DRAWN BY: KS
CHECKED BY: KS
ISSUE DATE: 01/31/2019

32407 Wilst Jan Gluposson

SHEET TITLE:
1st Floor Plan

SHEET NUMBER:

A2.1

ReZone - Design Review

0/2019 9:56:27 AM

1st Floor 3/32" = 1'-0"

Revisions # Description Date

K & I HOMES, LLC

6125 E INDIAN SCHOOL RD SUITE 2005 SCOTTSDALE, AZ 85251 PH: 602-505-2525

:::Clayton

7502 East 2nd Street Scottsdale, AZ

75 on 2nd

DRAWN BY: KS

CHECKED BY: KS ISSUE DATE: 01/31/2019



SHEET TITLE:
2nd Floor Plan


SHEET NUMBER:

A2.2

ReZone - Design Review

2-ZN-2019 2/14/19

1 2nd Floor 3/32" = 1'-0"

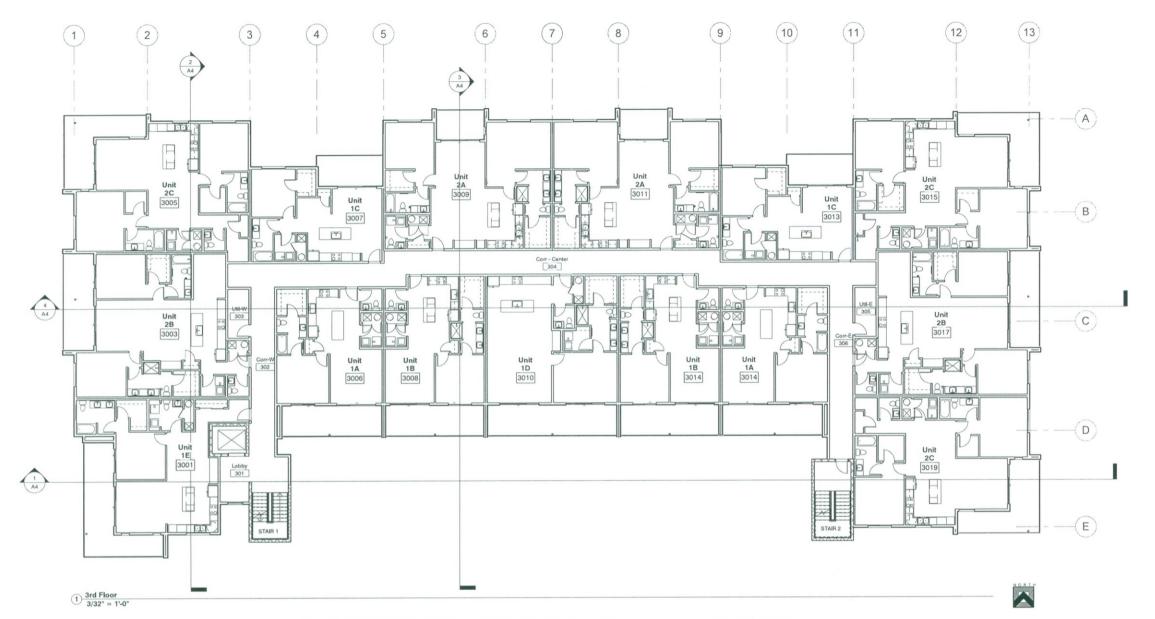

75 on 2nd	Unit Mix & Areas		Rezone / DRB			1/22/2019
	Gross Areas	Net Areas	Number of units per Building	Total	Total Gross Areas	Total Net Areas

	Gross Areas		Net Areas Number of units per Building			Total G		ss Areas	Total Net Areas			
Unit	Туре	Unit	Balcony	Total	Unit	2nd Flr	3rd Flr	4th Flr	Units	Units	Balconies	Units
							1 3					
1A	1Bed	836	207	1,043	778	2	2	2	6	5,016	1,242	4,668
1B		844	207	1,051	789	2	2	2	6	5,064	1,242	4.734
1C		748	134	882	691	2	2	2	6	4,488	804	4,146
1D		1,126	271	1,397	1,063	1	1	1	3	3,378	813	3,189
1E		1,054	296	1,350	977	1	1		2	2,108	592	1,954
												0
2A	2 Bed	1,361	95	1,456	1,280	2	2	2	6	8,166	570	7,680
2B		1,399	190	1,589	1,322	2	2		4	5,596	760	5,288
2C		1,360	222	1,582	1,281	3	3		6	8,160	1,332	7,686
Total				-		15	15		39	41 976	7 355	39 345

Average Unit Size and Ratios

Number of		Ave. Unit	Ave. Unit	Ratio	Ave. Balcony	
Units	Туре	Gross Area	Net Area		Area	
23	1 Bed	872	813	59.0%		
16	2 Bed	1,370	1,291	41.0%		
39	Average	876	815	100.0%	189	

Note: Gross Rentable Areas calculated from outside face (sheathing) of exterior wall

Net Unit Area calculated from inside face of finished walls (Paint to Paint)

BUILDING GROSS FLOOR AREAS: SF

Floor	Area
1ST FLOOR	22,002
2ND FLOOR	18,945
3RD FLOOR	18,945
4TH FLOOR	10,873
TOTAL	70,765

Gross Building Areas Measured from outside face of exterior wall sheathing

2-ZN-2019 2/14/19 K & I HOMES, LLC

8125 E INDIAN SCHOOL RD
SUITE 2006
SCOTTEDALE, A 86251
PH: 602-606-2825



:::Clayton

75 on 2nd

Description Date

OWNERSHIP OF DOCUMENTS

DRAWINGS AND SPECIFICATIONS AS INSTRUMENTS OF SERVICE ARE AND BHALL REMAIN THE PROJECT FOR WHICH THEY WERE PREPARED IS DEED/TED OR NOT, THEY ARE NOT TO DEED/TED OR NOT, THEY ARE NOT TO DEED/TED OR NOT, THEY ARE NOT TO DETERMINENT TO THES PROJECT EXCEPT BY AGREEMENT IN WRITING AND WITH APPROPHATE COMPRESATION TO K.

JOB NUMBER: 180 DRAWN BY: KS

CHECKED BY: KS ISSUE DATE: 01/31/201



SHEET TITLE:
3rd Floor Plan

SHEET NUMBER:

. . .

A2.3

2-ZN-2019 2/14/19

K & I HOMES, LLC



:::Clayton

7502 East 2nd Street Scottsdale, AZ 75 on 2nd

Revisions # Description Date

OWNERSHIP OF DOCUMENTS


DRAWN BY: Author

CHECKED BY: Checker



A2.4

ReZone - Design

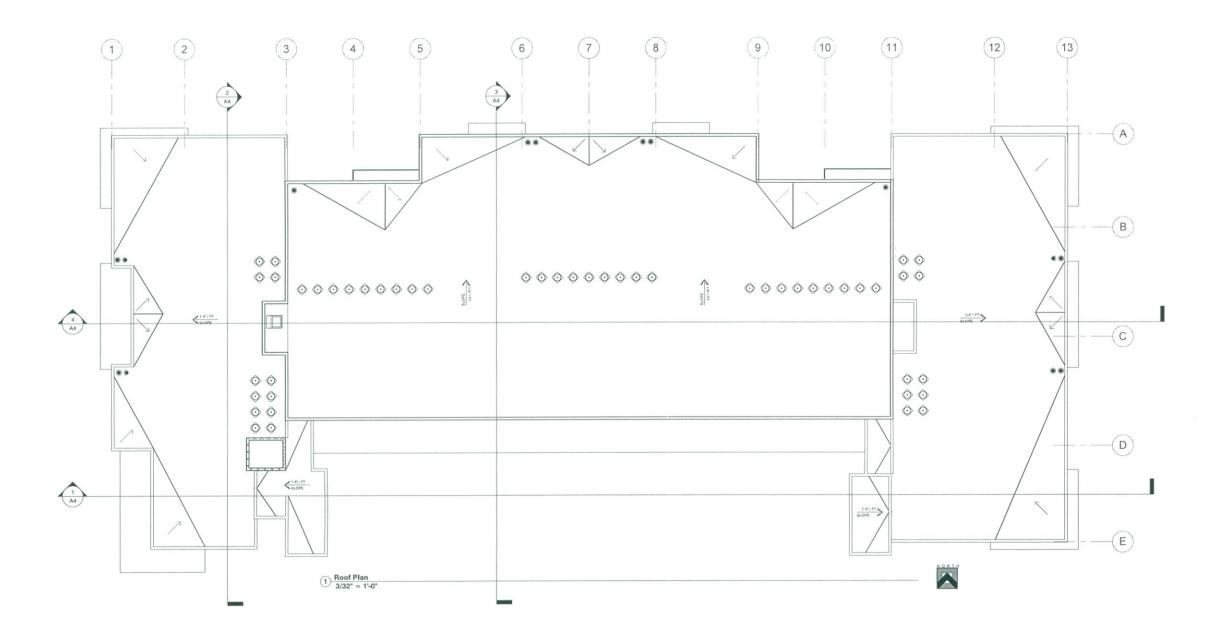

CONDENSING UNITS ON RAISED PLATFORM.

1/4" / FT SLOPE

ROOF SLOPE TO DRAIN 1/4" PER FOOT.

ROOF CRICKET SLOPE TO DRAIN

OF DRAIN AND OVERFLOW - REFER TO DETAIL 2 / A9.4

CONDENSING UNITS ON RAISED PLATFORM.

2-ZN-2019 2/14/19 K & I HOMES, LLC
6125 E INDIAN SCHOOL RD
SUTTE 2005
SCOTTSPALE, AZ 85251
PH: 602-505-2525



:::Clayton

75 on 2nd 7502 East 2nd Street Scottsdale, AZ

Revisions

Description Date

OWNERSHIP OF DOCUMENTS

DRAWMADS AND SPECIFICATIONS AS SHALL RESAMENT IN PROPERTY OF THE ARCHITECT WHETHER THE PROJECTS OF THE USED ON OTHER PROJECTS OF THE USED OF TH

CHECKED BY: KS
ISSUE DATE: 01/31/2019

32407
KRSTJAN
SIGURDSSON

M. Signon
SHEET TITLE:
Roof Plan

SHEET NUMBER:

A2.5

3/32" = 1'-0"

COLOR -

MATERIALS / KEY NOTES

STUCCO OVER PAPER BACKED METAL LATH ON EXT. GRADE PLYWOOD SHEATHING STUCCO OVER METAL LATH AND 1" FOAM ON EXT. GRADE PLYWOOD SHEATHING STUCCO OVER METAL LATH AND 1" FOAM OVER CMU STUCCO ONTROL JOINT BALCONT FACIA WITH METAL T-BAR AND STUCCO FINISH ROOF OVERHANG. STUCCO FRONT FACIA AND UNDERSIDE EXPOSED MASONNY. PUNNING BOND, RAKED JOINTS DECORATIVE FENCE BLOCK PANEL. STACKED BOND, RAKED JOINTS ALUMINUM STOREFRONT. FACTORY FINISH ALUMINUM STOREFRONT. TOODRS - SEE SCHEDULE SLIDING ALUMINUMICALASS PATIO DOORS. FACTORY FINISH - SEE SCHEDULE FIXED/SINGLE SUIDING ALUMINUM WINDOW. FACTORY FINISH - SEE SCHEDULE FIXED/SINGLE SUIDING ALUMINUM WINDOW. FACTORY FINISH - SEE SCHEDULE FIXED/SINGLA GARAGE DOOR - FACTORY FINISH - SEE SCHEDULE SECTIONAL GARAGE DOOR - FACTORY FINISH STEEL COLUMN. PAINTED
TUBE STEEL RAILING/GUARDRAIL - PAINTED
TOR SEAM METAL ROOF

STANDING SEAM METAL ROOF BUILDING SIGNAGE - UNDER SPEARATE PERMIT AND SUBMITTAL

GENERAL NOTES

STUCCO CYSTEM TO BE 'STO POWERWALL' OVER 1' INSULATION BOARD, WITH 1.0/FINE INTEGRAL COLORED FINISH TO MATCH PAINT COLOR SPECIFIED. SYSTEM TO BE INSTALLED OVER STO GURAD WITH GOLD COAT WATER RESISTIVE BARRIER, PER THE FOLLOWING EVALUATION REPORTS:

ESR-2323 STO POWERWALL STUCCO SYSTEM ESR-2323 STO POWERWALL STUCCO SYSTEM ESR-233 STO GUAPD WITH GOLD COAT WATER RESISTIVE BARRIERS STUCCO CONTROL JOINTS SHOWN AT TYPICAL LOCATIONS ONLY. PROVIDE ADDITIONAL CONTROL JOINTS SHOWN AT TYPICAL LOCATIONS ONLY. PROVIDE ADDITIONAL CONTROL JOINTS AS MAY BE REQUIRED AND RECCOMENDED BY STUCCO MANUFACTURER VERIFY LOCATION WITH ARCHITECT.

STUCCO CONTROL JOINTS AS MAY BE REQUIRED AND RECCOMENDED BY STUCCO MANUFACTURER VERIFY LOCATION WITH ARCHITECT.

STUCCO CONTROL JOINTS AS BATTO OF 1:2 1:2. TYPICAL JOINT PLACEMENTSINCLUDE: HORIZONTALLY AT EACH FLOOR LEVEL

VERTICALL FROM CORNER OF SLIDING DOORS, WINDOWS AND BALCONIES ALL CONTROL JOINTS S A REVEALS TO TERMINATE ON INSIDE CORNERS ONLY. PROVIDE SEALANT AT ALL STUCCO PENETRATIONS.

PAINT ALL EXTERIOR MOUNTED ELECTRICAL AND MECHANICAL PANELS/BOXES TO MATCH ADJACENT SURFACE OF THE BUILDING.

PAINT ALL EVERTOR MOUNTED ELECTRICAL AND MECHANICAL PANELS/BOXES TO MATCH ADJACENT SURFACE OF THE BUILDING.

PAINT ALL EVERTS, FLASHING, MISC, MATERIALS TO MATCH ADJ. BLDG. COLOR U.N.O. ALL PAINT COLOR CHANGES TO TERMINATE ON INSIDE CORNERS ONLY.

PROVIDE 2'S COLID CMUL CAPS AT ALL EXPOSED CMU. SITE WALLS

ALL EXPOSED DRYTER AND EXHAUST VENTS TO BE ALIGNED HORIZONTALLY (AT EACH FLOOR), AND PAINTED TO MATCH ADJACENT STUCCO COLOR.

2-ZN-2019

2/14/19

ADJACENT STUCCO COLOR
ALL EXPOSED CMU TO BE RUNING BOND, WITH RAKED JOINTS, U.N.O.

75 on 2nd

7502 East 2nd Street Scottsdale, AZ

K & I HOMES, LLC

6125 E INDIAN SCHOOL F SUITE 2005 SCOTTSDALE, AZ 85251 PH: 602-505-2525

::: Clayton

Revisions # Description Date

OWNERSHIP OF DOCUMENTS

DRAWINGS AND SPECIFICATIONS AS INSTITULATIONS OF BEFRICE ARE AND ADMINISTRATION OF BEFRICE ARE AND ADMINISTRATION OF THE ADMINISTRAT

JOB NUMBER: 1809 DRAWN BY: Author

CHECKED BY: Checker



SHEET TITLE:
Exterior Elevations

SHEET NUMBER:

ReZone - Design Review




PAINT: (DUNN EDWARDS 'DE')
A1. MAIN FIELD (LIGHT GRAY)
A2. 2ND FIELD (MEDIUM GRAY)
A3. ACCENT (DARK GRAY)
A4. ACCENT (TEAL)
A5. ACCENT (OPANGE) ALUMINUM STOREFRONT; (ARCADIA)
B1. AB-7 'STANDARD DARK BRONZE' SLIDING GLASS DOORS AND WINDOWS: (MILGARD)
B2. DARK BRONZE ANODIZED

COLORS

DE6372 - LACE VAIL DE6375 - CASTLEROCK DE6377 - BOAT ANCHOR DE7546 - OASIS DE5229 - CLAY TERRACE

WOOD GRAIN METAL SIDING; (RMP ROLLFAB)
D1. ALUMABOARD HAZELNUT BROWN 6° V-GROOVE

METAL ROOF PANELS (MORIN OR EQ.)
E1. CUSTOM COLOR TO MATCH PAINT A5

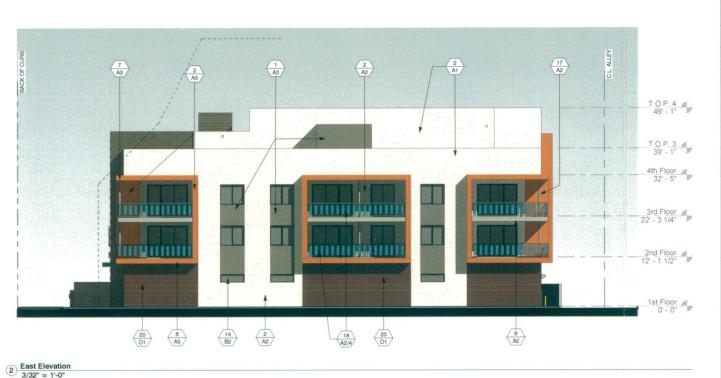

MATERIAL / COLOR SCHEDULE

COLOR -

MATERIALS / KEY NOTES

- STUCCO OVER PAPER BACKED METAL LATH ON EXT. GRADE PLYWOOD SHEATHING STUCCO OVER METAL LATH AND 1" FOAM ON EXT. GRADE PLYWOOD SHEATHING STUCCO ONTROL JOINT SHEATHING STUCCO ONTROL JOINT BALCONY FACIA WITH METAL T-BAR AND STUCCO FINISH ROOF OVERHANG. STUCCO FRONT FACIA AND UNDERSIDE EXPOSED MASONRY RUINNING BOND, RAKED JOINTS DECORATIVE FENCE BLOOF AVER, STORED SHORT SHEAT SH

- CMU REFUSE ENCLOSURE STANDING SEAM METAL ROOF
- BUILDING SIGNAGE UNDER SPEARATE PERMIT AND SUBMITTAL

GENERAL NOTES

STUCCO SYSTEM TO BE STO POWERWALL! OVER 11 INSULATION BOARD, WITH 1.0/FINE INTEGRAL COLORED FINISH TO MATCH PAINT COLOR SPECIFIED. SYSTEM TO BE INSTALLED OVER STO GURAD WITH GOLD COAT WATER RESISTIVE BARRIER, PER THE FOLLOWING PAULATION REPORTS:

ESR-2323 STO POWERWALL STUCCO SYSTEM ESR-2323 STO POWERWALL STUCCO SYSTEM ESR-2323 STO GUARD WITH GOLD COAT WATER RESISTIVE BARRIERS STUCCO CONTROL JOINTS SHOWN AT TYPICAL LOCATIONS ONLY. PROVIDE ADDITIONAL CONTROL JOINTS SHOWN AT TYPICAL LOCATIONS ONLY. PROVIDE ADDITIONAL CONTROL JOINTS AS MAY BE REQUIRED AND RECOMENDED BY STUCCO MANUFACTURER VERIFY LOCATION WITH ARCHITECT.

STUCCO CONTROL JOINTS AS MAY BE REQUIRED AND RECOMENDED BY STUCCO MANUFACTURER VERIFY LOCATION WITH ARCHITECT.

STUCCO CONTROL JOINTS AS REVEALS TO TERMINATE ON INSIDE CORNERS ONLY. PROVIDE SEALANT AT ALL STUCCO PENETRATIONS.

PAINT ALL EXTERIOR MOUNTED ELECTRICAL AND MECHANICAL PANELS/BOXES TO MATCH ADJACENT SUPFACE OF THE BUILDING.

PAINT ALL EXTERIOR MOUNTED ELECTRICAL AND MECHANICAL PANELS/BOXES TO MATCH ADJACENT SUPFACE OF THE BUILDING.

PAINT ALL EVENTS, FLASHING, MISC MATERIALS TO MATCH ADJ. BLDG. COLOR U.N.O. ALL PAINT COLOR CHANGES TO TERMINATE ON INSIDE CORNERS ONLY.

PROVIDE 2'S SOLID CHILD CAPS AT ALL EXPOSED CMM SITE WALLS

ALL EXPOSED DRYPER AND EXHAUST VENTS TO BE ALIGNED HORIZONTALLY (AT EACH FLOOR), AND VERTICALLY (FROM FLOOR TO FLOOR) AND PAINTED TO MATCH ADJACENT STUCCO COLOR

ADJACENT STUCCO COLOR
ALL EXPOSED CMU TO BE RUNING BOND, WITH RAKED JOINTS, U.N.O.

COLORS

DE6372 - LACE VAIL DE6375 - CASTLEROCK DE6377 - BOAT ANCHOR DET546 - OASIS DE5229 - CLAY TERRACE

ALUMINUM STOREFRONT; (ARCADIA)
B1. AB-7 'STANDARD DARK BRONZE'

SLIDING GLASS DOORS AND WINDOWS: (MILGARD)
B2. DARK BRONZE ANODIZED

 MASONRY (SUPERLITE BLOCK)
 C1.
 8x8x16
 INTEGRALLY COLORED SMOOTH FACE - MW GRAY

 C2.
 8x8x16
 INTEGRALLY COLORED SMOOTH FACE - BLACK

 C3.
 4x1x12
 ELDORADO (#7) - MW GRAY

 C4.
 8X8x16
 MESASTONE, TEXTURED - RUTHERFORD

WOOD GRAIN METAL SIDING: (RMP ROLLFAB)
D1. ALUMABOARD HAZELNUT BROWN 6° V-GROOVE

METAL ROOF PANELS (MORIN OR EQ.)
E1. CUSTOM COLOR TO MATCH PAINT A5

2-ZN-2019 2/14/19

Revisions

75 on 2nd

K & I HOMES, LLC

6125 E INDIAN SCHOOL F SUITE 2005 SCOTTSDALE, AZ 85251 PH: 602-505-2525

::: Clayton

Street AZ

7502 East 2nd S Scottsdale, A

Description Date

DOCUMENTS

JOB NUMBER: 1809

DRAWN BY: KS

CHECKED BY: KS SSUE DATE: 01/31/2019



Exterior Elevations

ReZone - Design

MATERIAL / COLOR SCHEDULE COLOR -MATERIALS / KEY NOTES **GENERAL NOTES** STUCCO OVER PAPER BACKED METAL LATH ON EXT. GRADE PLYWOOD SHEATHING STUCCO OVER METAL LATH AND 1" FOAM ON EXT. GRADE PLYWOOD SHEATHING STUCCO OVER METAL LATH AND 1" FOAM OVER CMU STUCCO ONTROL JOINT BALCONT FACIA WITH METAL T-BAR AND STUCCO FINISH ROOF OVERHANG - STUCCO FRONT FACIA WITH METAL T-BAR AND STUCCO FINISH ROOF OVERHANG - STUCCO FRONT FACIA WND UNDERSIDE EXPOSED MASONINY - RUNNING BOND, RAKED JOINTS DECORATIVE FENCE BLOCK FANIEL - STACKED BOND, RAKED JOINTS ALUMINUM STOREFRONT - FACTORY FINISH ALUMINUM STOREFRONT - FACTORY FINISH ALUMINUM STOREFRONT - TOORS - SEE SCHEDULE SLIDING ALUMINUM/SIASS PATIO DOORS - FACTORY FINISH - SEE SCHEDULE FIXED/SINISE SLIDING ALUMINUM WINDOW - FACTORY FINISH - SEE SCHEDULE HOLLOW METAL DOOR AND FRAME - PAINTED - SEE SCHEDULE SECTIONAL GRANGE DOOR - FACTORY FINISH STEEL COLUMN - PAINTED TUBE STEEL VIEW / POOL FENCE - PAINTED TUBE STEEL VIEW / POOL FENCE - PAINTED TUBE STEEL VIEW / POOL FENCE - PAINTED HORZONTAL METAL SIDING CMU REPUSE ENCLOSURE STANDING SEMM METAL ROOF BUILDING SIGMAGE - UNDER SPEARATE PERMIT AND SUBMITTAL STUCCO SYSTEM TO BE 'STO POWERWALL' OVER 1' INSULATION BOARD, WITH 1,0/FINE INTEGRAL COLORED FINISH TO MATCH PAINT COLOR SPECIFIED, SYSTEM TO BE INSTALLED OVER STO GUARD WITH GOLD COAT WATER RESISTIVE BARRIER, PER THE FOLLOWING EVALUATION REPORTS:

ESR-323 STO GUARD WITH GOLD COAT WATER RESISTIVE BARRIERS STUCCO CONTROL, JOINS S A SMAY BE REQUIRIED AND RECOMENDED BY STUCCO MANUFACTURER VERIFY LOCATION WITH ARCHITECT.

STUCCO CONTROL, JOINS AS MAY BE REQUIRIED AND RECCOMENDED BY STUCCO MANUFACTURER VERIFY LOCATION WITH ARCHITECT.

STUCCO CONTROL, JOINS TO BE PROVIDED SO THAT MAY, STUCCO PANEL SIZE IS 144 SF, WITH A WIDH TO LEADHT RATIO OF 12 IZ. TYPICAL JOINT PLACEMENTSINCLUDE:

HORIZONTALLY AT EACH FLOOR LEVEL

VERTIFICAL FROM CONNER OF SUDING DOORS, WINDOWS AND BALCONIES ALL CONTROL, JOINTS & REVEALS TO TERMINATE ON INSIDE CONNERS ONLY.

PROVIDE SEALANT AT ALL STUCCO PENETRATIONS.

PIANT ALL EXTENDER MOUNTED ELECTRICAL AND MECHANICAL PANELS/BOXES TO MATCH ADJACENT SURFACE OF THE BULING. TO MATCH ADJACENT SURFACE OF THE BULING.

PLANT ALL EXTENDER MOUNTED ELECTRICAL AND MECHANICAL PANELS/BOXES TO PAIL OF THE MATCH ADJACENT SURFACE OF THE BULING.

PLANT ALL EXTENDER MOUNTED ELECTRICAL AND MECHANICAL PANELS/BOXES TO PAIL OF THE MATCH ADJACENT SURFACE OF THE BULING.

PLANT ALL EXTENDER MOUNTED ELECTRICAL AND MECHANICAL PANELS/BOXES TO PAIL OF THE MATCH ADJACENT SURFACE OF THE BULING.

PLANT ALL EXTENDER MOUNTED ELECTRICAL AND MECHANICAL PANELS/BOXES TO PAIL STORMS ON THE PAIL OF THE MATCH ADJACENT SURFACE OF THE BULING.

ALL EXPOSED DRYCE AND EXHAUST VENTS TO BE AUGUSED HORIZONTALLY AT EACH FLOOR, AND VERTICALLY FROM FLOOR TO FLOOR ON THE MATCH ADJACENT SUCCOOLOR STUCCO SYSTEM TO BE 'STO POWERWALL' OVER 1" INSULATION BOARD, WITH 1,0/FINE COLORS DE6372 - LACE VAIL DE6375 - CASTLEROCK DE6377 - BOAT ANCHOR DET546 - OASIS DE5229 - CLAY TERRACE - LRV 77 - LRV 43 - LRV 14 - LRV 24 - LRV 29 ALUMINUM STOREFRONT: (ARCADIA)
B1. AB-7 STANDARD DARK BRONZE ANODIZED SLIDING GLASS DOORS AND WINDOWS: (MILGARD)
B2. DARK BRONZE ANODIZED | MASONRY (SUPERLITE BLOCK) | C1. 8x8x16 | INTEGRALLY COLORED SMOOTH FACE - MW GRAY | C2. 8x8x16 | INTEGRALLY COLORED SMOOTH FACE - BLACK | C3. 4X12X12 | ELDCHADO (x7) - MW GRAY | C4. 8XXX16 | MESASTONE. TEXTURED - RUTHERFORD

WOOD GRAIN METAL SIDING: (RMP ROLLFAB)
D1. ALUMABOARD HAZELNUT BROWN 6° V-GROOVE

METAL ROOF PANELS (MORIN OR EQ.)
E1. CUSTOM COLOR TO MATCH PAINT A5

South Elevation
3/32" = 1'-0"

(17) A2) (7) A5) T.O.P. 4 49' - 1" T.O.P. 3 39' - 1" 4th Floor 32' - 5" 1111441111111 3rd Floor 22' - 3 1/4" 2nd Floor 12' - 1 1/2" 23 9 6 C4 A5

::: Clayton

K & I HOMES, LLC

6125 E INDIAN SCHO SUITE 2005 SCOTTSDALE, AZ 8 PH: 602-505-252

2nd Stre East 2nd soutsdale, ON 2 7502 I Sc 1

Description Date

DOCUMENTS DOCUMENTS

DOWNING AND PRICIPICATIONS AS INSTITUTENTS OF SERVICE ARE AND SMALL REMAIN THE PROPERTY OF THE ARCHITECT WHETHER THE PROJECT TO BE USED ON OTHER PROJECTS OF THE ARCHITECT WAS ASSOCIATED WHETHER AND WITH A WELLOW AND WELLOW AND WITH A WELLOW AND WITH A WELLOW AND WITH A WELLOW AND WITH A WELLOW AND WELLOW AND A WELLOW AND

DRAWN BY: Author HECKED BY: Checke





Exterior Elevations

SHEET NUMBER


2-ZN-2019

2/14/19

A3.1

ReZone - Design

West Elevation
3/32" = 1'-0"

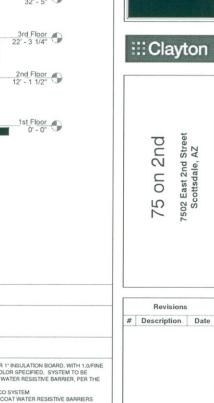


K&I HOMES, LLC

6125 E INDIAN SCHOOL R SUITE 2005 SCOTTSDALE, AZ 85251 PH: 602-505-2525

7502 East 2nd Street Scottsdale, AZ

Revisions

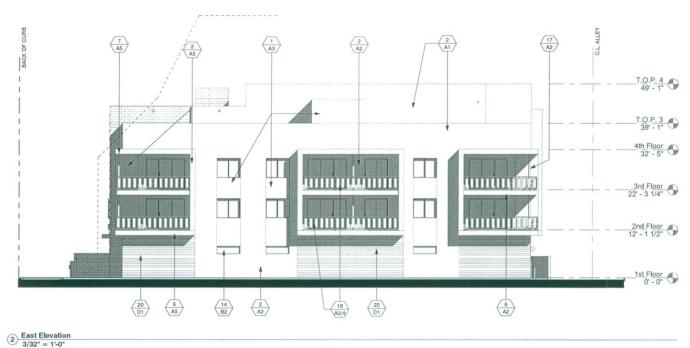

MATERIALS / KEY NOTES	GENERAL NOTES				
1. STUCCO OVER PAPER BACKED METAL LATH ON EXT. GRADE PLYWOOD SHEATHING 2. STUCCO OVER METAL LATH AND I* FOAM ON EXT. GRADE PLYWOOD SHEATHING 3. STUCCO OVER METAL LATH AND I* FOAM ON EXT. GRADE PLYWOOD SHEATHING 4. STUCCO OVER METAL LATH AND I* FOAM OVER CMU 4. STUCCO CONTROL, JOINT 6. BALCONY FACIA WITH METAL T-BAR AND STUCCO FINISH 7. ROOF OVERHANG - STUCCO FRONT FACIA AND UNDERSIDE 9. EXPOSED MASONIY - RUNNING BOND, RAKED JOINTS 10. DECORATIVE FENCE BLOCK FANEL - STACKED BOND, RAKED JOINTS 11. ALJAINIMM STOREFRONT - FACTORY FINISH 12. ALJAINIMM STOREFRONT - FACTORY FINISH 13. SLUDING ALJAINIMM WINDOW - FACTORY FINISH - SEE SCHEDULE 14. FIXED/SINGLE SLIDING ALJAINIMM WINDOW - FACTORY FINISH - SEE SCHEDULE 15. HOLLOW METAL DOOR AND FRAME - PAINTED - SEE SCHEDULE 16. SECTIONAL GARAGE DOOR - FACTORY FINISH 17. STEEL COLUMN - PAINTED 18. TUBE STEEL RAILING/GUARDRAIL - PAINTED 19. TUBE STEEL HEW PY DOOL FENCE - PAINTED 20. HORIZONTAL METAL SIDING 21. CMU REFUSE ENCLOSURE 22. STANDING SEAM METAL ROOF 23. BUILDING SIGNAGE - UNDER SPEARATE PERMIT AND SUBMITTAL	1. STUCCO SYSTEM TO BE 'STO POWERWALL' OVER 1' INSULATION BOARD, WITH 1, INTEGRAL COLORED FINISH TO MATCH PAINT COLOR SPECIFIED, SYSTEM TO BE INSTALLED OVER 5TO GUIRDA WITH GALO COAT WATER RESISTIVE BARRIER, PER FOLLOWING SPELIATION REPORTS OF THE GOLD COAT WATER RESISTIVE BARRIER SER 528, STAP ONWER SER 5123 STO GUARDA WITH GOLD COAT WATER RESISTIVE BARRIER SER 1233 STO GUARDA WITH GOLD COAT WATER RESISTIVE BARRIER ADDITIONAL CONTROL JOINTS A SWAY BE REQUIRED AND RECCOMENDED BY STO GUARDA WATER SERVING SERVING SER 5123 STO GUARDA WITH PARCHETECT. 3. STUCCO CONTROL JOINTS AS MAY BE REQUIRED AND RECCOMENDED BY STO MANUFACTURER VERIEN LOCATION WITH A ROWSHIT CO. STATE SERVING SE				
COLORS					
PAINT_(DUNN EDWARDS 'DE)					
SLIDING GLASS DOORS AND WINDOWS: (MILGARD) B2. DARK BRONZE ANODIZED					
MASONRY (SUPERILITE BLOCK) Masonry (Super					


OWNERSHIP OF DOCUMENTS DOCUMENTS

ORWANDS AND SPECIFICATIONS AS INSTRUVENTS OF SERVICE ARE AS STALL REMAIN THE PROPERTY OF SERVICE ARE AS STALL REMAIN THE PROPERTY OF SERVICE ARE NOT THE VIEW PROJECTS OF SERVICE AS INSTRUMENTS OF SERVICE COMPENSATION TO WARPENDAMENT IN WARRING AND APPROPRIATE COMPENSATION TO WORKS, LLC.

JOB NUMBER: 1809 DRAWN BY: KS CHECKED BY: KS ISSUE DATE: 01/31/2019 L. Signoun SHEET TITLE:
Exterior Elevations SHEET NUMBER: A3.2

> ReZone - Design Review

1/28/2019 4:21

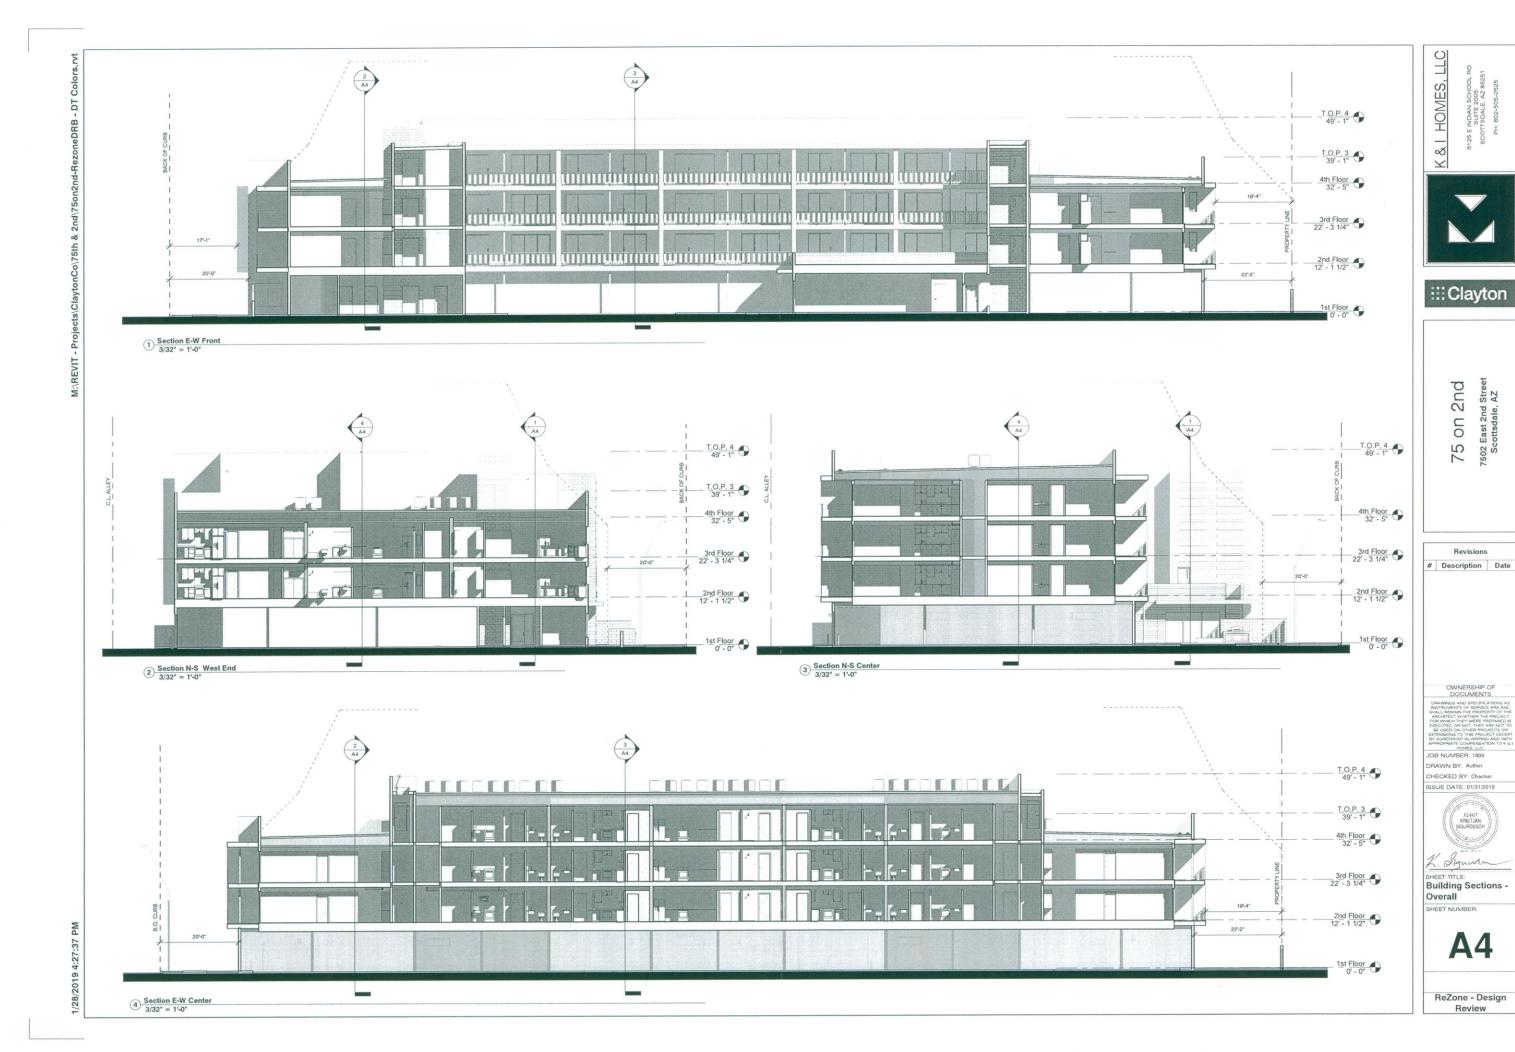

K&I HOMES, LLC



::: Clayton

7502 East 2nd Street Scottsdale, AZ

75 on 2nd

Revisions # Description Date

JOB NUMBER: 1809 DRAWN BY: KS CHECKED BY: KS
ISSUE DATE: 01/31/2019

K. Signon
SHEET TITLE:
Renderings

A5

ReZone - Design

2-ZN-2019 2/14/19

PERSPECTIVE VIEW FROM SOUTHEAST



PERSPECTIVE VIEW FROM SOUTHWEST

HOMES,

<u>~</u>

SCHG 2005



iPIXELstudios

2nd Stre East 2nd O 75 7502 E Sco

Revisions # Description Date

DOCUMENTS

DRAWN BY: DSS HECKED BY: DSS




Landscape Plan

THIS SITE

__

ReZone - Design Review

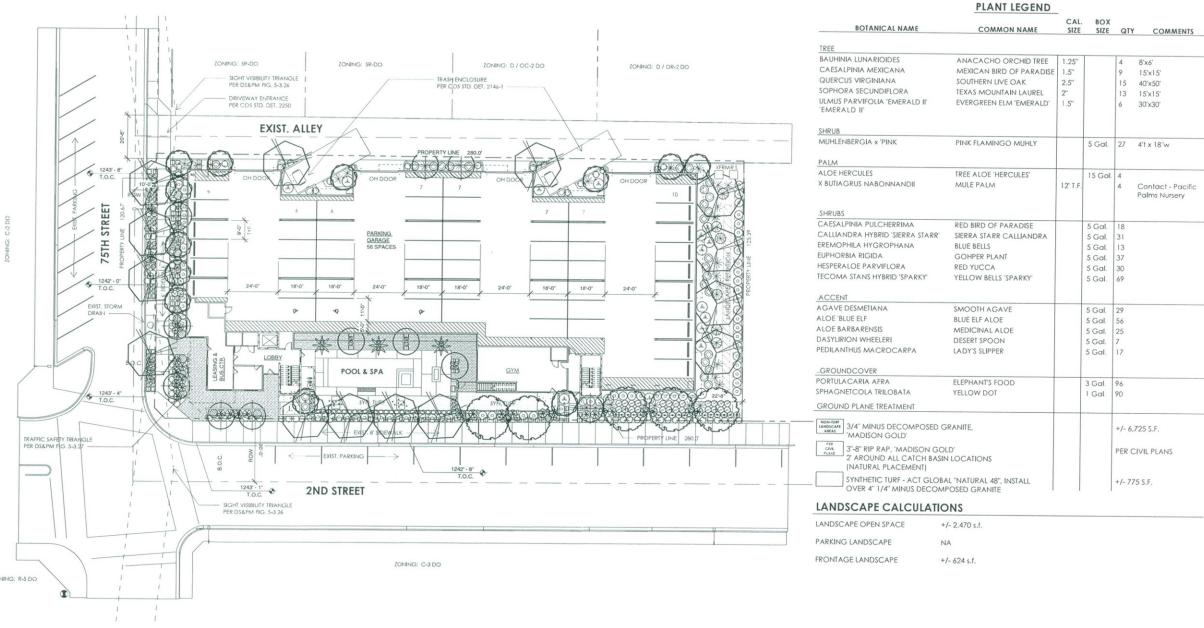

LANDSCAPE NOTES

CONCEPTUAL LANDSCAPE PLAN

- DECOMPOSED GRANITE OR SIMILAR MATERIAL AROUND THE MATURE FORM OF A SPECIMEN PLANT, TREE CANOPY, OR GROUPS OF PLANTS, SHALL NOT EXCEED SEVEN (7) FEET IN ANY DIRECTION, PER ZONING ORDINANCE SECTION 10.501.A.
- 2. ALL TREES SHALL BE FIFTEEN (15) GALLON MINIMUM SIZE, AND A LEAST FIFTY (50) PERCENT SHALL BE MATURE TREES WITH A MINIMUM 2" CALIPER.

VICINITY MAP

- 3. THIS PROJECT CONTAINS NO NEW PARKING / LANDSCAPE AREAS & REQUIREMENTS.
- 4. ALL PLANT MATERIALS SHALL BE FROM THE ARIZONA DEPARTMENT OF WATER RESOURCE'S (ADWR) PHOENIX ACTIVE MANAGEMENT AREA PLANT LIST & IS EXEMPT FROM THE CITY OF SCOTTSDALE'S ENVIRONMENTALLY SENSITIVE LANDS ORDINANCE (ESLO) PLANT LIST.
- 5. THIS PROJECT DOES NOT CONTAIN ANY NATURAL AREA OPEN SPACE (NAOS).
- 6. NO NATIVE PLANT INVENTORY & SALVAGE REQUIRED FOR THIS LOCATION.
- THORNY SHRUBS AND CACTI SHALL BE PLANTED SO THAT THEIR MATURE SIZE/CANOPY WILL BE AT LEAST 4 FEET AWAY FROM ANY WALKWAYS OR PARKING AREA CURBING. PER DSPM SEC. 2-1.1001.13.
- 8. ALL SIDEWALKS TO BE A MIN. 6'-0" CLEAR.
- 9. ALL FIRELANE SURFACES SHALL SUPPORT 83,000 LBS GROSS VEHICULAR WEIGHT PER DS & PM 2-1.802(3)
- 10.ALL LANDSCAPE AREAS SHALL BE IRRIGATED BY AUTOMATIC UNDERGROUND IRRIGATION SYSTEM.
- 11.REFER TO CIVIL FOR ALL GRADING, DRAINAGE, RETENTION AREAS, SETBACKS, EASEMENTS & P.U.E. LOCATIONS

DOCUMENTS

DRAWN BY: KS

CHECKED BY: KS SSUE DATE: 5/1/2019



Cover Sheet

SHEET NUMBER:

A0.1

ReZone2 - Design Review1





SHEET INDEX

Cover sheet Context Aerial A0.2

AS2 **ALTA SURVEY**

Conceptual Cover Sheet Conceptual Grading and Drainage Plan Conceptual Utility Plan

Preliminary Landscape Plan Preliminary Landscape Plan - Lighting

Architectural:
A1.1 Site Plan
A1.2 Site Plan - Worksheet
A2.1 1st / Ground Floor Plan
A2.2 2nd Floor Plan
A2.3 3rd Floor Plan
A2.4 4th Floor Plan
A2.5 Roof Plan
A3.1 Exterior Elevations
A3.2 Exterior Elevations
A3.3 Exterior Elevations - Wo
A4 Building Sections

Exterior Elevations -Building Sections Renderings

Photometrics and Light Fixture Cut Sheets E0.1-4

APPLICANT / ARCHITECT

K&I HOMES, LLC 6125 E Indian School Rd #2005 SCOTTSDALE, AZ 85251

602-505-2525 KRISTJAN SIGURDSSON

SCOTTSDALE, AZ 85251

OWNER / DEVELOPER

2-ZN-2019

05/10/2019


2 3D View - from NW 12" = 1'-0"

DRAWN BY: KS



SHEET TITLE:
Context Aerial

A0.2

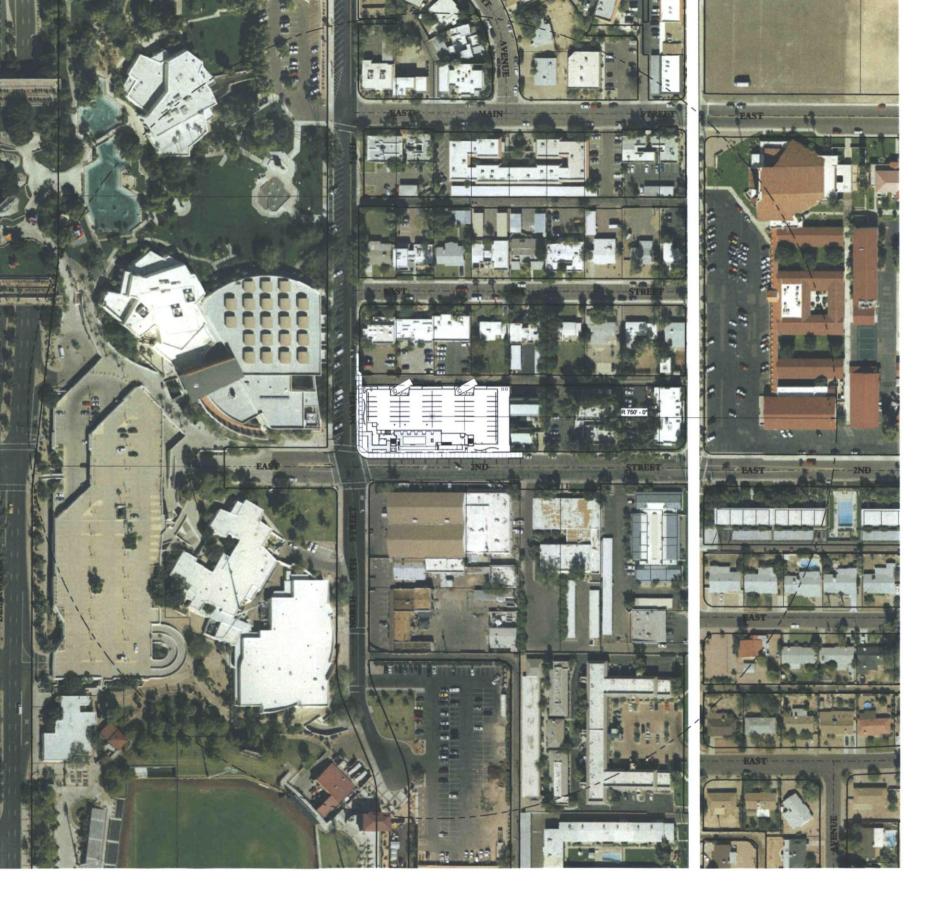

HOMES,

~ŏ

2005 E, AZ



::: Clayton

on 2nd Str East 2nd 75 7502 E

Description Date

OWNERSHIP OF

DOCUMENTS

RAWN BY: KS CHECKED BY: KS SUE DATE: 5/1/2019



Digueda

Site Plan

SHEET NUMBER

ReZone2 - Design

Review1


EQUIPMENT SHALL BE SCREENED BY A SCREEN WALL THAT MATCHES THE ARCHITECTURAL COLOR AND ARCHITECTURAL FINISH OF THE BUILDING, WHICH IS A MINIMUM OF 1'-0" HIGHER THAN THE HIGHEST OF THE TALLEST UNIT. (DETAILS ARE STILL REQUIRED).

ALL EQUIPMENT, UTILITIES, OR OTHER APPURTENANCES ATTACHED TO THE BUILDING SHALL BE AN INTEGRAL PART OF THE BUILDING DESIGN INTERMS OF FORM, COLOR NO EXTERIOR VISIBLE LADDERS SHALL BE ALLOWED.

ALL POLE-MOUNTED LIGHTING SHALL BE A MAXIMUM OF 20'-0" IN HEIGHT.

NO TURF AREAS SHALL BE PROVIDED.

NO CHAIN LINK FENCING SHALL BE ALLOWED.

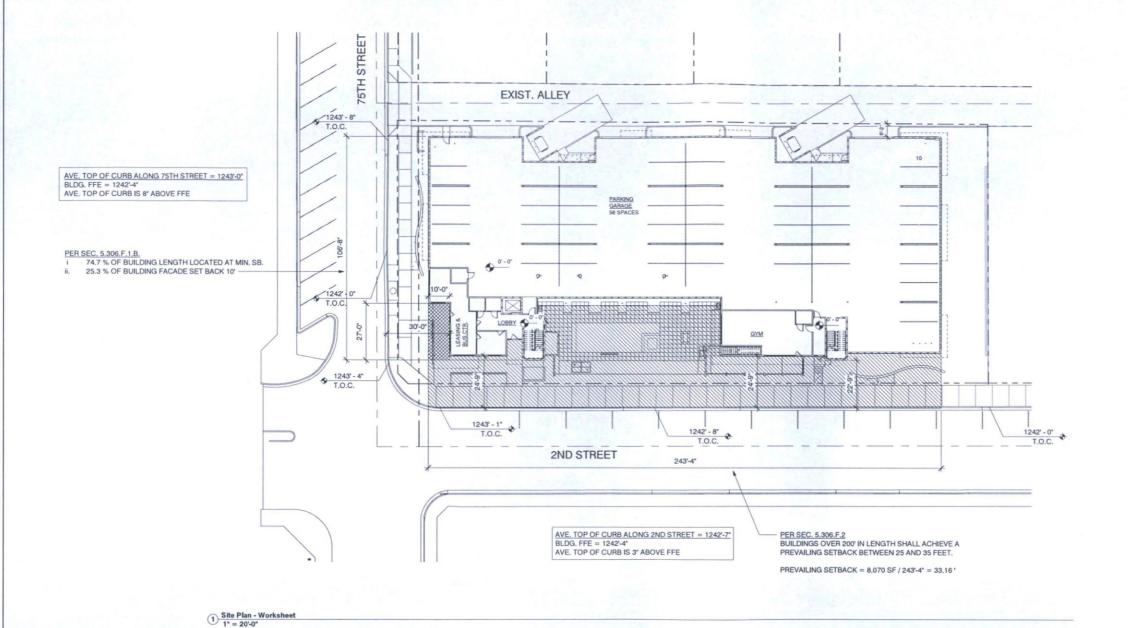

K & I HOMES, LLC



6126 E. INDIAN SCHOOL R SUTTE 2005 SCOTTSDALE, AZ 85251 PH: 602-505-2525

:::Clayton

75 on 2nd

Revisions

Description Date

OWNERSHIP

DOCUMENTS

CRAWNOS AND SPECIFICATIONS AS INSTRUMENTS OF SERVICE ARE AN SHALL REMAIN THE PROPERTY OF TARCHED WHETHER THE PROPERTY OF THE PROPER


JOB NUMBER: 1809 DRAWN BY: KS

CHECKED BY: KS ISSUE DATE: 5/1/2019



SHEET TITLE:
Site Plan Worksheet
SHEET NUMBER:

A1.2

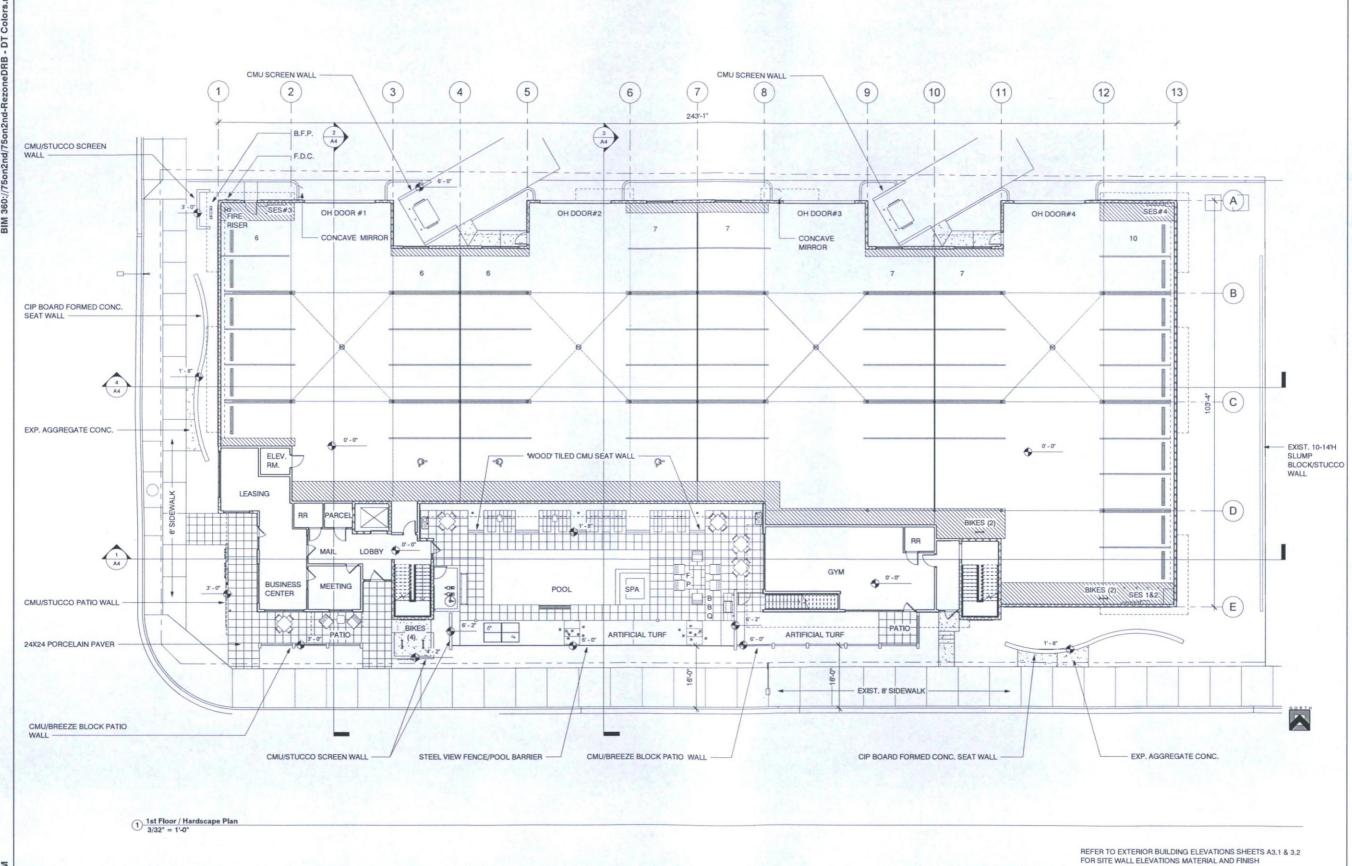

K & I HOMES, LLC

6125 E. INDIAN SCHOOL P SUITE 2005 SCOTTSDALE, AZ 85251 PH: 602-505-2525



::: Clayton

75 on 2nd

Revisions # Description Date

| Description | Da

OWNERSHIP OF

PAWINGS AND SPECIFICATIONS AS STRUMENTS OF SERVICE ARE AND ALL REMAIN THE PROPERTY OF THE ROHIECT WHETHER THE PROJECT IF WHICH THEY WERE PREPARED IS ECUTED OR NOT, THEY ARE NOT TO SE USED ON OTHER PROJECTS OR TENSIONS TO THIS PROJECT SCEN

HOMES, LLC.

JOB NUMBER: 1809

DRAWN BY: KS


CHECKED BY: KS


ISSUE DATE: 5/1/2019




1st Floor Plan / Hardscape Plan

A2.1

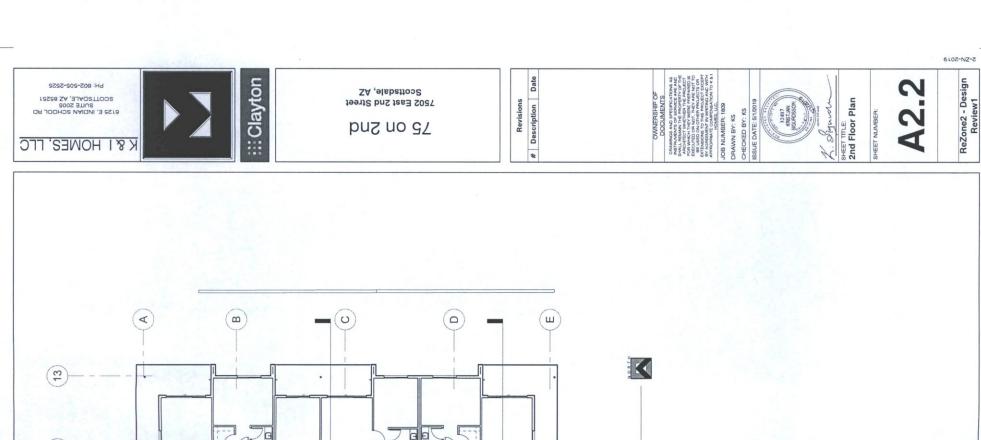

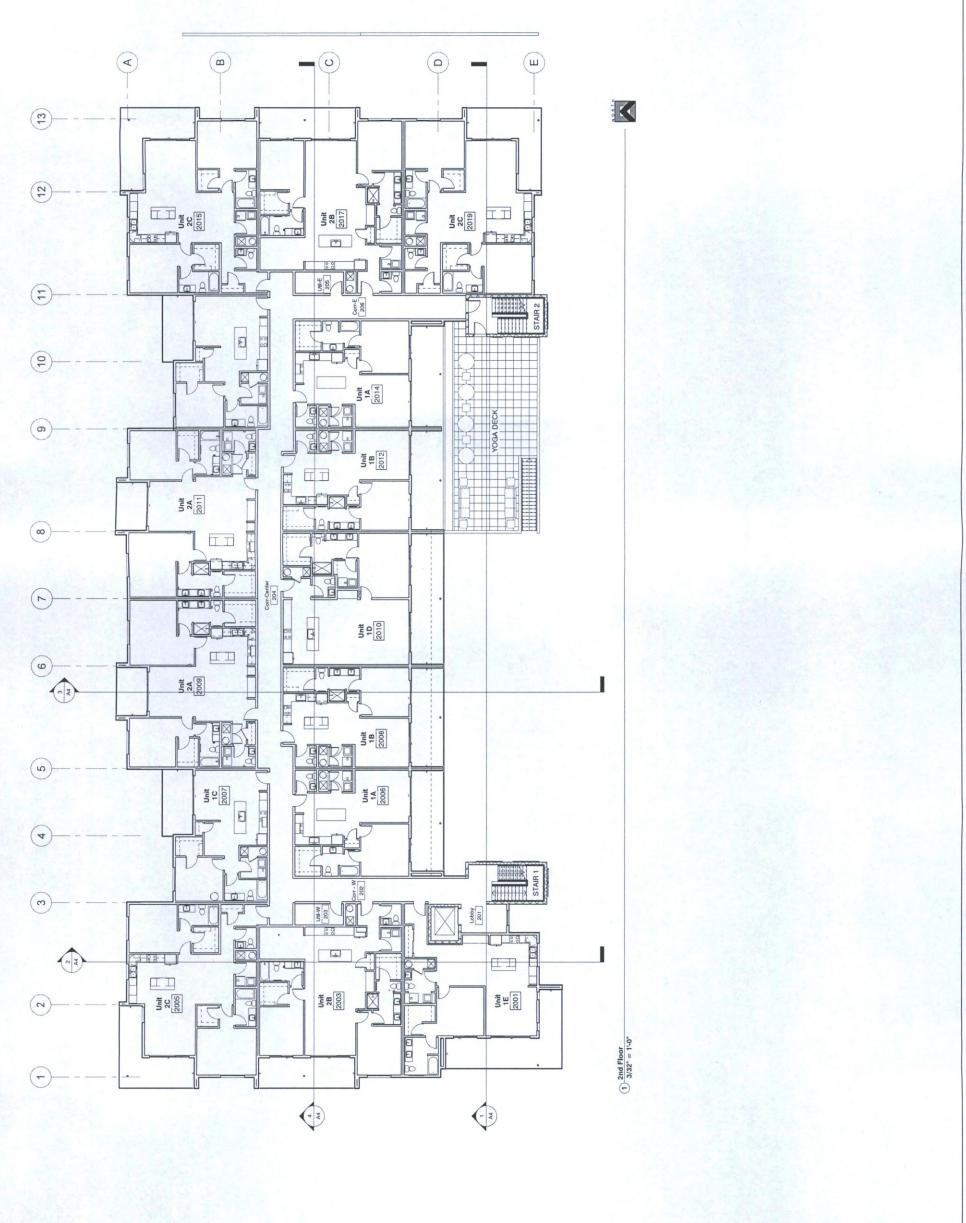



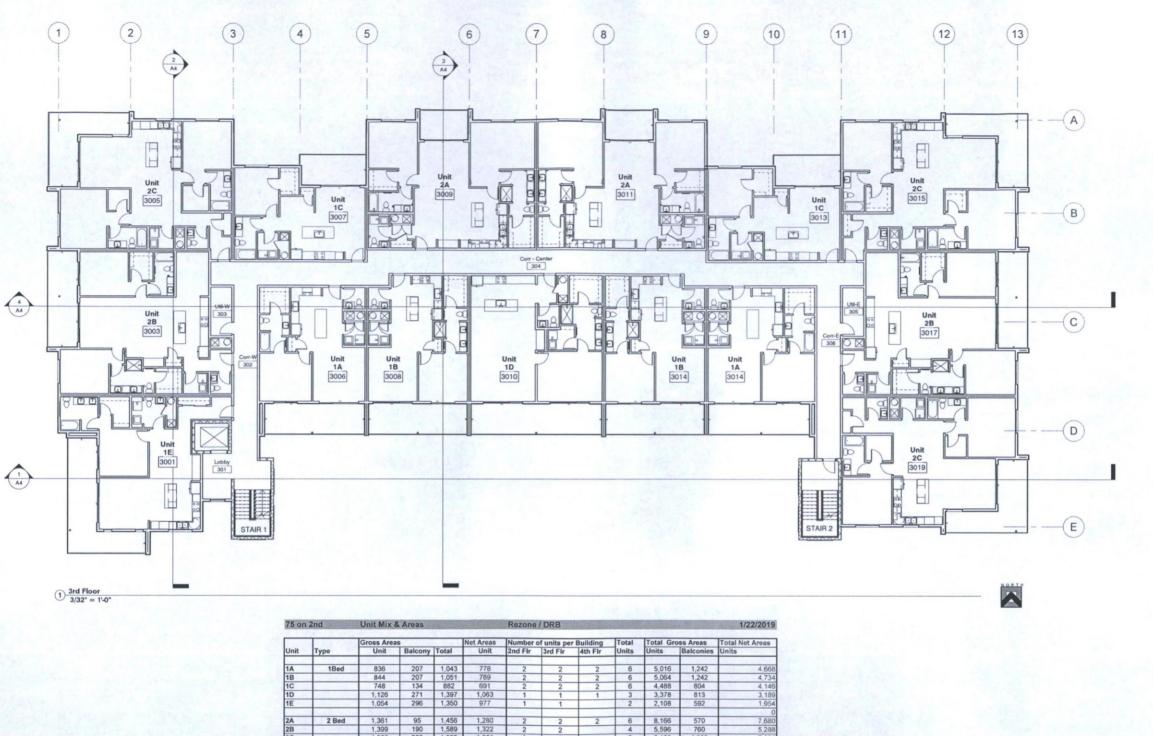

1	- FOR 10 M	Gross Areas		Net Areas Number of units per Building			Total	Total Gross Areas		Total Net Areas			
Unit	Unit	Туре	Unit	Balcony	Total	Unit	2nd Flr	3rd Flr	4th Flr	Units	Units	Balconies	Units
1A	1Bed	836	207	1,043	778	2	2	2	6	5.016	1,242	4,668	
1B	1 1 2 1 7	844	207	1,051	789	2	2	2	6	5,064	1,242	4,734	
1C		748	134	882	691	2	2	2	6	4,488	804	4,146	
1D		1,126	271	1,397	1,063	1	1	1	3	3,378	813	3,189	
1E		1,054	296	1,350	977	1	1		2	2,108	592	1,954	
2A	2 Bed	1,361	95	1,456	1,280	2	2	2	6	8,166	570	7,680	
2B		1,399	190	1,589	1,322	2	2		4	5,596	760	5,288	
2C		1,360	222	1,582	1,281	3	3	1000	6	8,160	1,332	7,686	
Total						15	15		9 39	41,976	7,355	39.345	

Average Unit Size and Ratios

Numbe	rof	Ave. Unit	Ave. Unit	Ratio	Ave. Balcony		
Units	Туре	Gross Area	Net Area		Area		
23	1 Bed	872	813	59.0%			
16	2 Bed	1,370	1,291	41.0%			
39	Average	876	815	100.0%	189		

Gross Rentable Areas calculated from outside face (sheathing) of exterior wall

Net Unit Area calculated from inside face of finished walls (Paint to Paint)

BUILDING GROSS FLOOR AREAS: SF

Floor	Area
1ST FLOOR	22,002
2ND FLOOR	18,945
3RD FLOOR	18,945
4TH FLOOR	10,873
TOTAL	70,765

Gross Building Areas Measured from outside face of exterior wall sheathing

::: Clayton

K & I HOMES, LLC

6125 E. INDIAN SCHOOL R SUITE 2005 SCOTTSDALE, AZ 85251 PH: 802-505-2525

7502 East 2nd Street Scottsdale, AZ 75 on 2nd

Description Date


DRAWN BY: KS CHECKED BY: KS



L. Signion

3rd Floor Plan

SHEET NUMBER:

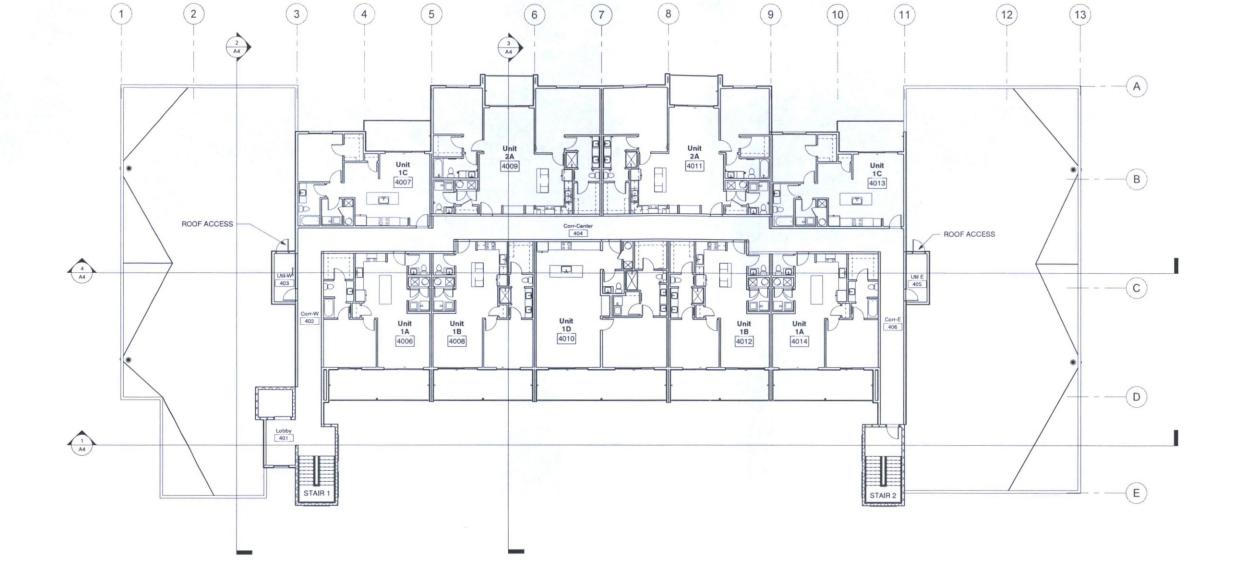

K & I HOMES, LLC

6125 E. INDIAN SCHOOL RE SUITE 2005 SCOTTSDALE, AZ 85251 PH: 602-505-2525



:::Clayton

7502 East 2nd Street Scottsdale, AZ 75 on 2nd

Revisions

Description Date

JOB NUMBER: 1809 DRAWN BY: Author

CHECKED BY: Checker ISSUE DATE: 5/1/2019




4th Floor Plan

SHEET NUMBER:

ReZone2 - Design Review1

1 4th Floor 3/32" = 1'-0"

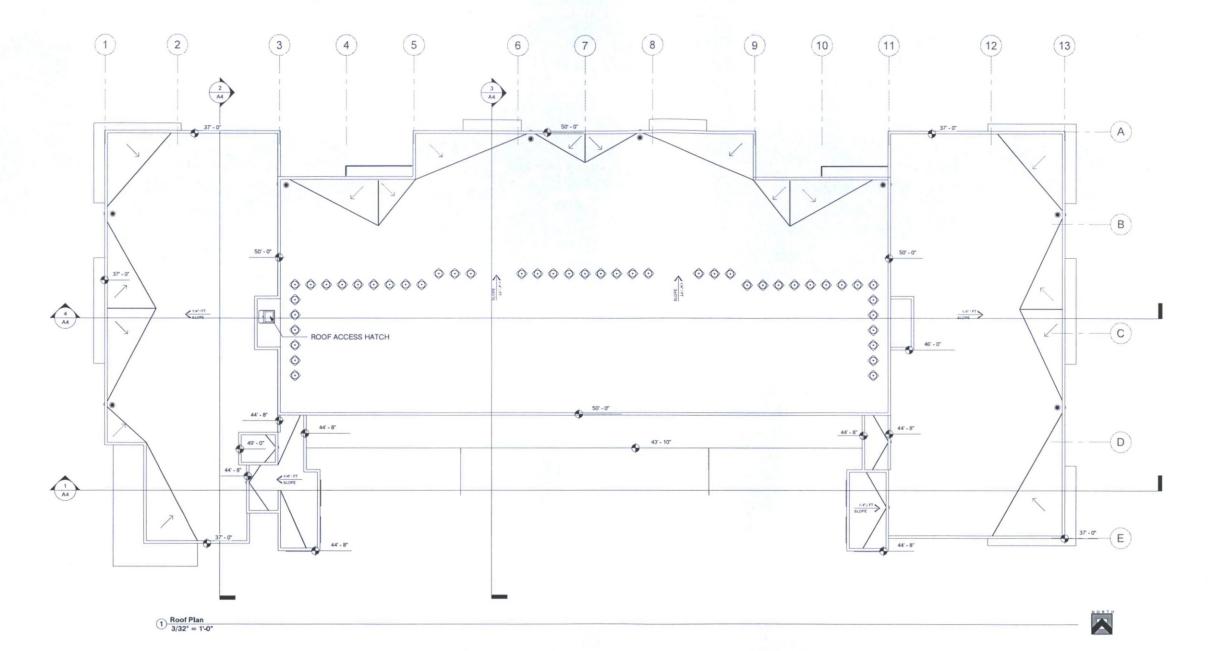

1/4" / FT SLOPE TO DRAIN 1/4" PER FOOT.

ROOF CRICKET SLOPE TO DRAIN ROOF DRAIN AND OVERFLOW SCUPPER

CONDENSING UNITS ON RAISED PLATFORM SCREENED BY BUILDING PARAPET

0' - 0" HEIGHT OF ELEMENT A.F.F. (0'-0')

K & I HOMES, LLC

6125 E. INDIAN SCHOOL R SUITE 2005 SCOTTSDALE, AZ 85251 PH: 602-505-2525



:::Clayton

7502 East 2nd Street Scottsdale, AZ 75 on 2nd

Revisions

Description Date

DRAWN BY: KS CHECKED BY: KS

ISSUE DATE: 5/1/2019

L. Signon

SHEET TITLE: Roof Plan

SHEET NUMBER:

A2.5

(g) T.O.P. 4 T.O.P. 3 37' - 0" 3rd Floor 22' - 11 3/8" 2nd Floor 12' - 3 1/2"

MATERIAL / COLOR SCHEDULE

X COLOR -

MATERIALS / KEY NOTES

- STUCCO OVER PAPER BACKED METAL LATH ON EXT. GRADE
- STUCCO OVER METAL LATH AND 1° FOAM ON EXT. GRADE
- STUCCO OVER METAL LATH AND1" FOAM OVER CMU STUCCO CONTROL JOINT
- BALCONY FACIA WITH METAL T-BAR AND STUCCO FINISH ROOF OVERHANG - STUCCO FRONT FACIA AND UNDERSIDE
- EXPOSED MASONRY RUNNING BOND, BAKED JOINTS
- DECORATIVE FENCE BLOCK PANEL STACKED BOND
- ALUMINUM STOREFRONT FACTORY FINISH ALUMINUM STOREFRONT / DOORS SEE SCHEDULE
- SLIDING ALUMINUM/GLASS PATIO DOORS FACTORY FINISH FIXED/SINGLE SLIDING ALUMINUM WINDOW FACTORY FINISH
- HOLLOW METAL DOOR AND FRAME PAINTED SEE SCHEDULE SECTIONAL GARAGE DOOR FACTORY FINISH
- STEEL COLUMN PAINTED
 TUBE STEEL RAILING/GUARDRAIL PAINTED
- TUBE STEEL VIEW / POOL FENCE PAINTED HORIZONTAL METAL SIDING
- CMU REFUSE ENCLOSURE STANDING SEAM METAL ROOF
- BUILDING SIGNAGE UNDER SPEARATE PERMIT AND SUBMITTAL CMU SITE/SCREEN WALL WITH STUCCO FINISH

- 12"W CAST IN PLACE BOARD FORMED CONCRETE SEAT/SITE WALL COLOR AND TEXTURE TO MATCH CLAYTON HOUSE

GENERAL NOTES

- STUCCO SYSTEM TO BE STO POWERWALL OVER 1° INSULATION BOARD, WITH 1.0/FINE INTEGRAL COLORED FINISH TO MATCH PAINT COLOR SPECIFIED. SYSTEM TO BE INSTALLED OVER STO GUARD WITH GOLD COAT WATER RESISTIVE BARRIER, PER THE
 - FOLLOWING EVALUATION REPORTS:
 ESR-2323 STO POWERWALL STUCCO SYSTEM
 - ESR-1233 STO GUARD WITH GOLD COAT WATER RESISTIVE BARRIERS - OR APPROVED EQUAL STUCCO CONTROL JOINTS SHOWN AT TYPICAL LOCATIONS ONLY.
- PROVIDE ADDITIONAL CONTROL JOINTS AS MAY BE REQURIED AND RECCOMENDED BY STUCCO MANUFACTURER VERIFY LOCATION WITH ARCHITECT.
- STUCCO CONTROL JOINTS TO BE PROVIDED SO THAT MAX. STUCCO PANEL SIZE IS 144 SF, WITH A WIDTH TO LENGHT RATIO OF 1:2 1/2. TYPICAL JOINT PLACEMENTSINCLUDE:
- HORIZONTALLY AT EACH FLOOR LEVEL VERTICALL FROM CORNER OF SLIDING DOORS, WINDOWS AND BALCONIES
- ALL CONTROL JOINTS & REVEALS TO TERMINATE ON INSIDE CORNERS ONLY.
- PROVIDE SEALANT AT ALL STUCCO PENETRATIONS.
- PAINT ALL EXTERIOR MOUNTED ELECTRICAL AND MECHANICAL PANELS/BOXES TO MATCH ADJACENT SURFACE OF THE
- BUILDING. PAINT ALL VENTS, FLASHING, MISC. MATERIALS TO MATCH ADJ.
- BLDG. COLOR U.N.O.
 ALL PAINT COLOR CHANGES TO TERMINATE ON INSIDE CORNERS
- PROVIDE 2" OR 4" SOLID CMU CAPS AT ALL EXPOSED CMU SITE
- ALL EXPOSED DRYER AND EXHAUST VENTS TO BE ALIGNED HORIZONTALLY (AT EACH FLOOR), AND VERTICALLY (FROM FLOOR TO FLOOR) AND PAINTED TO MATCH ADJACENT
- ALL EXPOSED CMU TO BE STACKED OR RUNNING BOND AS SHOWN, WITH RAKED JOINTS, U.N.O.

COLORS

ı	PAIN	T: (DUNN ED	WARDS 'DE'		
ı	A1.	MAIN FIELD	(LIGHT)	DW314 - DESERT STAR	- LRV 8
1	A2.	2ND FIELD	(MEDIUM)	DET625 - RECLAIMED WOOD	- LRV 4
ı	A3.	ACCENT	(DARK)	DET626 - METAL FRINGE	- LRV 2
1	A4.	ACCENT	(TEAL)	DET546 - OASIS	- LRV 2
1	AF	ACCENIT	CORANCE	DEEDOO CLAV TERRACE	LDVO

ALUMINUM STOREFRONT: (ARCADIA) B1. AB-7 'STANDARD DARK BRONZE' ANODIZED

SLIDING GLASS DOORS AND WINDOWS: (MILGARD)
B2. DARK BRONZE ANODIZED

MASONRY (SUPERLITE BLOCK)
C1. 4x8x16 INTEGRAL COLOR SMOOTH FACE - MW GRAY C2. 4X10X16 INTEGRAL COLOR SMOOTH FACE - MW GRAY 2" OFFSET CORE SHADOW BLOCK C3. 8y8y16 INTEGRAL COLOR SMOOTH FACE - CHARCOA MASONRY (ORCO BLOCK)

C4. 4X12X12 SQUARE ON SQUARE BREEZE BLOCK

WOOD GRAIN METAL SIDING: (RMP ROLLFAB)
D1. ALUMABOARD HAZELNUT BROWN 6" V-GROOVE

METAL ROOF PANELS (MORIN OR EQ.)
E1. CUSTOM COLOR TO MATCH PAINT A5

& I HOMES,



SUITE 2005 SUITE 2005 TSDALE, AZ 8

::: Clayton

Street AZ 75 on 2nd 7502 East 2nd S Scottsdale, A

Description Date

DOCUMENTS

RAWN BY: Author HECKED BY: Checke SUE DATE: 5/1/2019



Exterior Elevations

HEET NUMBER

- MW GRAY



9 C3 7 A5 1 A3 A3 / T.O.P 4 T.O.P. 3 3rd Floor 22' - 11 3/8" 2nd Floor 12' - 3 1/2" 75

MATERIAL / COLOR SCHEDULE

MATERIAL X

MATERIALS / KEY NOTES

- STUCCO OVER PAPER BACKED METAL LATH ON EXT. GRADE PLYWOOD SHEATHING STUCCO OVER METAL LATH AND 1" FOAM ON EXT. GRADE
- PLYWOOD SHEATHING
- STUCCO CONTROL JOINT
- BALCONY FACIA WITH METAL T-BAR AND STUCCO FINISH ROOF OVERHANG STUCCO FRONT FACIA AND UNDERSIDE
- EXPOSED MASONRY RUNNING BOND, RAKED JOINTS DECORATIVE FENCE BLOCK PANEL STACKED BOND
- ALUMINUM STOREFRONT FACTORY FINISH
- ALUMINUM STOREFRONT / DOORS SEE SCHEDULE
- SLIDING ALUMINUM/GLASS PATIO DOORS FACTORY FINISH
- FIXED/SINGLE SLIDING ALUMINUM WINDOW FACTORY FINISH HOLLOW METAL DOOR AND FRAME PAINTED SEE SCHEDULE
- SECTIONAL GARAGE DOOR FACTORY FINISH STEEL COLUMN PAINTED
- TUBE STEEL RAILING/GUARDRAIL PAINTED
- TUBE STEEL VIEW / POOL FENCE PAINTED HORIZONTAL METAL SIDING
- CMU REFUSE ENCLOSURE
- STANDING SEAM METAL ROOF
- BUILDING SIGNAGE UNDER SPEARATE PERMIT AND SUBMITTAL CMU SITE/SCREEN WALL WITH STUCCO FINISH
- - 12"W CAST IN PLACE BOARD FORMED CONCRETE SEAT/SITE WALL COLOR AND TEXTURE TO MATCH CLAYTON HOUSE

GENERAL NOTES

- STUCCO SYSTEM TO BE 'STO POWERWALL' OVER 1" INSULATION BOARD, WITH 1.0/FINE INTEGRAL COLORED FINISH TO MATCH PAINT COLOR SPECIFIED. SYSTEM TO BE INSTALLED OVER STO GUARD WITH GOLD COAT WATER RESISTIVE BARRIER, PER THE
- STUCCO OVER METAL LATH AND1" FOAM OVER CMU FOLLOWING EVALUATION REPORTS:
 ESR-2323 STO POWERWALL STUCCO SYSTEM

- LRV 24

- ESR-1233 STO GUARD WITH GOLD COAT WATER RESISTIVE BARRIERS - OR APPROVED FOUAL
- STUCCO CONTROL JOINTS SHOWN AT TYPICAL LOCATIONS ONLY. PROVIDE ADDITIONAL CONTROL JOINTS AS MAY BE REQURIED AND RECCOMENDED BY STUCCO MANUFACTURER VERIFY
- LOCATION WITH ARCHITECT.
 STUCCO CONTROL JOINTS TO BE PROVIDED SO THAT MAX. STUCCO PANEL SIZE IS 144 SF, WITH A WIDTH TO LENGHT RATIO OF 1:2 1/2. TYPICAL JOINT PLACEMENTSINCLUDE:
- HORIZONTALLY AT EACH FLOOR LEVEL VERTICALL FROM CORNER OF SLIDING DOORS, WINDOWS AND BALCONIES
- ALL CONTROL JOINTS & REVEALS TO TERMINATE ON INSIDE CORNERS ONLY.
- PROVIDE SEALANT AT ALL STUCCO PENETRATIONS.
- PAINT ALL EXTERIOR MOUNTED ELECTRICAL AND MECHANICAL PANELS/BOXES TO MATCH ADJACENT SURFACE OF THE BUILDING.
- PAINT ALL VENTS, FLASHING, MISC. MATERIALS TO MATCH ADJ. BLDG, COLOR U.N.O.
 ALL PAINT COLOR CHANGES TO TERMINATE ON INSIDE CORNERS
- PROVIDE 2" OR 4" SOLID CMU CAPS AT ALL EXPOSED CMU SITE WALLS
- ALL EXPOSED DRYER AND EXHAUST VENTS TO BE ALIGNED HORIZONTALLY (AT EACH FLOOR), AND VERTICALLY (FROM FLOOR TO FLOOR) AND PAINTED TO MATCH ADJACENT STUCCO COLOR
- ALL EXPOSED CMU TO BE STACKED OR RUNNING BOND AS SHOWN, WITH RAKED JOINTS, U.N.O.

COLORS

- PAINT: (DUNN EDWARDS 'DE')
 A1.
 Main Field (Light)
 DW314 - DESERT STAR
 - LRV 81

 A2.
 2ND FIELD (MEDIUM)
 DET625 - RECLAIMED WOOD - LRV 47

 A3.
 ACCENT (DARK)
 DET626 - METAL FRINGE - LRV 21
- A4. ACCENT (TEAL) DET546 OASIS A5. ACCENT (ORANGE) DE5229 CLAY TERRACE - LRV 29

ALUMINUM STOREFRONT: (ARCADIA)
B1. AB-7 'STANDARD DARK BRONZE' ANODIZED

SLIDING GLASS DOORS AND WINDOWS: (MILGARD)
B2. DARK BRONZE ANODIZED

MASONRY (SUPERLITE BLOCK)

INTEGRAL COLOR SMOOTH FACE C2. 4X10X16 INTEGRAL COLOR SMOOTH FACE 2" OFFSET CORE SHADOW BLOCK

C3. 8x8x16 INTEGRAL COLOR SMOOTH FACE - CHARCOAL MASONRY (ORCO BLOCK) C4. 4X12X12 SQUARE ON SQUARE BREEZE BLOCK - MW GRAY

WOOD GRAIN METAL SIDING: (RMP ROLLFAB)

D1. ALUMABOARD HAZELNUT BROWN 6" V-GROOVE METAL ROOF PANELS (MORIN OR EQ.) E1. CUSTOM COLOR TO MATCH PAINT A5

Revisions

Description Date

on 2nd

75

Stre East 2nd Soutsdale, A

SUITE 2005 TSDALE, AZ 8

OWNERSHIP OF DOCUMENTS

DRAWN BY: Author

HECKED BY: Checker



Exterior Elevations

SHEET NUMBER

- MW GRAY



West Elevation (75th Street) 3/32" = 1'-0"

MATERIAL / COLOR SCHEDULE

MATERIALS / KEY NOTES

- STUCCO OVER PAPER BACKED METAL LATH ON EXT. GRADE PLYWOOD SHEATHING STUCCO OVER METAL LATH AND 1" FOAM ON EXT. GRADE
- PLYWOOD SHEATHING STUCCO OVER METAL LATH AND1" FOAM OVER CMU
- STUCCO CONTROL JOINT
- BALCONY FACIA WITH METAL T-BAR AND STUCCO FINISH ROOF OVERHANG STUCCO FRONT FACIA AND UNDERSIDE
- EXPOSED MASONRY RUNNING BOND, RAKED JOINTS DECORATIVE FENCE BLOCK PANEL STACKED BOND
- ALUMINUM STOREFRONT FACTORY FINISH
- ALUMINUM STOREFRONT / DOORS SEE SCHEDULE SLIDING ALUMINUM/GLASS PATIO DOORS - FACTORY FINISH
- FIXED/SINGLE SLIDING ALUMINUM WINDOW FACTORY FINISH HOLLOW METAL DOOR AND FRAME PAINTED SEE SCHEDULE
- SECTIONAL GARAGE DOOR FACTORY FINISH STEEL COLUMN PAINTED
- TUBE STEEL RAILING/GUARDRAIL PAINTED
- CMU REFUSE ENCLOSURE

- 12"W CAST IN PLACE BOARD FORMED CONCRETE SEAT/SITE WALL 7.

- TUBE STEEL VIEW / POOL FENCE PAINTED
- HORIZONTAL METAL SIDING
- STANDING SEAM METAL ROOF
- BUILDING SIGNAGE UNDER SPEARATE PERMIT AND SUBMITTAL CMU SITE/SCREEN WALL WITH STUCCO FINISH
- COLOR AND TEXTURE TO MATCH 'CLAYTON HOUSE

GENERAL NOTES

- STUCCO SYSTEM TO BE 'STO POWERWALL' OVER 1" INSULATION BOARD, WITH 1.0/FINE INTEGRAL COLORED FINISH TO MATCH PAINT COLOR SPECIFIED. SYSTEM TO BE INSTALLED OVER STO GUARD WITH GOLD COAT WATER RESISTIVE BARRIER, PER THE
- FOLLOWING EVALUATION REPORTS: ESR-2323 STO POWERWALL STUCCO SYSTEM ESR-1233 STO GUARD WITH GOLD COAT WATER RESISTIVE
- BARRIERS OR APPROVED EQUAL STUCCO CONTROL JOINTS SHOWN AT TYPICAL LOCATIONS ONLY. PROVIDE ADDITIONAL CONTROL JOINTS AS MAY BE REQURIED
- AND RECCOMENDED BY STUCCO MANUFACTURER VERIFY LOCATION WITH ARCHITECT. STUCCO CONTROL JOINTS TO BE PROVIDED SO THAT MAX.
- STUCCO PANEL SIZE IS 144 SF, WITH A WIDTH TO LENGHT RATIO OF 1:2 1/2. TYPICAL JOINT PLACEMENTSINCLUDE: HORIZONTALLY AT EACH FLOOR LEVEL
- VERTICALL FROM CORNER OF SLIDING DOORS, WINDOWS AND BALCONIES
- ALL CONTROL JOINTS & REVEALS TO TERMINATE ON INSIDE CORNERS ONLY.
- PROVIDE SEALANT AT ALL STUCCO PENETRATIONS. PAINT ALL EXTERIOR MOUNTED ELECTRICAL AND MECHANICAL
- PANELS/BOXES TO MATCH ADJACENT SURFACE OF THE BUILDING. PAINT ALL VENTS, FLASHING, MISC. MATERIALS TO MATCH ADJ.
- BLDG. COLOR U.N.O.
 ALL PAINT COLOR CHANGES TO TERMINATE ON INSIDE CORNERS PROVIDE 2" OR 4" SOLID CMU CAPS AT ALL EXPOSED CMU SITE
- WALLS ALL EXPOSED DRYER AND EXHAUST VENTS TO BE ALIGNED HORIZONTALLY (AT EACH FLOOR), AND VERTICALLY (FROM FLOOR TO FLOOR) AND PAINTED TO MATCH ADJACENT STUCCO COLOR
- ALL EXPOSED CMU TO BE STACKED OR RUNNING BOND AS SHOWN, WITH RAKED JOINTS, U.N.O.

COLORS

PAINT: (DUNN EDWARDS 'DE') A1. MAIN FIELD (LIGHT) DW314 - DESERT STAR A2. 2ND FIELD (MEDIUM) DET625 - RECLAIMED WOOD - LRV 47
A3. ACCENT (DARK) DET626 - METAL FRINGE - LRV 21

ACCENT (TEAL) DET546 - OASIS - LRV 24 (ORANGE) DE5229 - CLAY TERRACE - LRV 29 A5 ACCENT

ALUMINUM STOREFRONT: (ARCADIA)
B1. AB-7 'STANDARD DARK BRONZE' ANODIZED

SLIDING GLASS DOORS AND WINDOWS: (MILGARD)
B2. DARK BRONZE ANODIZED

MASONRY (SUPERLITE BLOCK)

INTEGRAL COLOR SMOOTH FACE - MW GRAY C2. 4X10X16 INTEGRAL COLOR SMOOTH FACE - MW GRAY 2" OFFSET CORE SHADOW BLOCK C3. 8x8x16 INTEGRAL COLOR SMOOTH FACE - CHARCOAL

MASONRY (ORCO BLOCK) C4. 4X12X12 SQUARE ON SQUARE BREEZE BLOCK - MW GRAY

WOOD GRAIN METAL SIDING; (RMP ROLLFAB)
D1. ALUMABOARD HAZELNUT BROWN 6° V-GROOVE

METAL ROOF PANELS (MORIN OR EQ.)
E1. CUSTOM COLOR TO MATCH PAINT A5

& I HOMES, LLC



... Clayton

on 2nd East 2nd Stree 75

Revisions

Description Date

OWNERSHIP OF DOCUMENTS

DRAWN BY: Author HECKED BY: Checke



Exterior Elevations

(Streetscape) SHEET NUMBER

MATERIAL / COLOR SCHEDULE

MATERIAL COLOR -

MATERIALS / KEY NOTES

- STUCCO OVER PAPER BACKED METAL LATH ON EXT. GRADE
- PLYWOOD SHEATHING STUCCO OVER METAL LATH AND 1° FOAM ON EXT. GRADE
- PLYWOOD SHEATHING STUCCO OVER METAL LATH AND1" FOAM OVER CMU
- STUCCO CONTROL JOINT
- BALCONY FACIA WITH METAL T-BAR AND STUCCO FINISH
- ROOF OVERHANG STUCCO FRONT FACIA AND UNDERSIDE EXPOSED MASONRY - RUNNING BOND, RAKED JOINTS
- DECORATIVE FENCE BLOCK PANEL STACKED BOND ALUMINUM STOREFRONT - FACTORY FINISH
- ALUMINUM STOREFRONT / DOORS SEE SCHEDULE
- SLIDING ALUMINUM/GLASS PATIO DOORS FACTORY FINISH FIXED/SINGLE SLIDING ALUMINUM WINDOW - FACTORY FINISH
- HOLLOW METAL DOOR AND FRAME PAINTED SEE SCHEDULE SECTIONAL GARAGE DOOR FACTORY FINISH
- STEEL COLUMN PAINTED
- TUBE STEEL RAILING/GUARDRAIL PAINTED
- TUBE STEEL VIEW / POOL FENCE PAINTED HORIZONTAL METAL SIDING
- 21. CMU REFUSE ENCLOSURE 22. STANDING SEAM METAL ROOF
- BUILDING SIGNAGE UNDER SPEARATE PERMIT AND SUBMITTAL CMU SITE/SCREEN WALL WITH STUCCO FINISH
- 12"W CAST IN PLACE BOARD FORMED CONCRETE SEAT/SITE WALL COLOR AND TEXTURE TO MATCH 'CLAYTON HOUSE'
- LOCATION WITH ARCHITECT. STUCCO CONTROL JOINTS TO BE PROVIDED SO THAT MAX. STUCCO PANEL SIZE IS 144 SF. WITH A WIDTH TO LENGHT RATIO

GENERAL NOTES

OF 1:2 1/2. TYPICAL JOINT PLACEMENTSINCLUDE: HORIZONTALLY AT EACH FLOOR LEVEL VERTICALL FROM CORNER OF SLIDING DOORS, WINDOWS

STUCCO SYSTEM TO BE 'STO POWERWALL' OVER 1" INSULATION

BOARD, WITH 1.0/FINE INTEGRAL COLORED FINISH TO MATCH PAINT COLOR SPECIFIED. SYSTEM TO BE INSTALLED OVER STO

GUARD WITH GOLD COAT WATER RESISTIVE BARRIER, PER THE

ESR-1233 STO GUARD WITH GOLD COAT WATER RESISTIVE BARRIERS - OR APPROVED EQUAL

STUCCO CONTROL JOINTS SHOWN AT TYPICAL LOCATIONS ONLY.
PROVIDE ADDITIONAL CONTROL JOINTS AS MAY BE REQURIED

AND RECCOMENDED BY STUCCO MANUFACTURER VERIFY

FOLLOWING EVALUATION REPORTS:
ESR-2323 STO POWERWALL STUCCO SYSTEM

- AND BALCONIES
- ALL CONTROL JOINTS & REVEALS TO TERMINATE ON INSIDE
- CORNERS ONLY.
- PROVIDE SEALANT AT ALL STUCCO PENETRATIONS.
- PAINT ALL EXTERIOR MOUNTED ELECTRICAL AND MECHANICAL PANELS/BOXES TO MATCH ADJACENT SURFACE OF THE BUILDING.
- PAINT ALL VENTS. FLASHING, MISC. MATERIALS TO MATCH ADJ. RIDG COLORUNO ALL PAINT COLOR CHANGES TO TERMINATE ON INSIDE CORNERS
- PROVIDE 2" OR 4" SOLID CMU CAPS AT ALL EXPOSED CMU SITE
- WALLS
- ALL EXPOSED DRYER AND EXHAUST VENTS TO BE ALIGNED HORIZONTALLY (AT EACH FLOOR), AND VERTICALLY (FROM FLOOR TO FLOOR) AND PAINTED TO MATCH ADJACENT
- STUCCO COLOR ALL EXPOSED CMU TO BE STACKED OR RUNNING BOND AS SHOWN, WITH RAKED JOINTS, U.N.O.

COLORS

PAINT: (DUNN EDWARDS 'DE') A1. MAIN FIELD (LIGHT) DW314 - DESERT STAR - LRV 81
A2. 2ND FIELD (MEDIUM) DET625 - RECLAIMED WOOD - LRV 47 A3. ACCENT (DARK) DET626 - METAL FRINGE - LRV 21 A4. ACCENT (TEAL) DET546 - OASIS A5. ACCENT (ORANGE) DE5229 - CLAY TERRACE

ALUMINUM STOREFRONT: (ARCADIA) B1. AB-7 'STANDARD DARK BRONZE' ANODIZED

SLIDING GLASS DOORS AND WINDOWS: (MILGARD)
B2. DARK BRONZE ANODIZED

MASONRY (SUPERLITE BLOCK)

INTEGRAL COLOR SMOOTH FACE C2. 4X10X16 INTEGRAL COLOR SMOOTH FACE

2" OFFSET CORE SHADOW BLOCK C3. 8x8x16 INTEGRAL COLOR SMOOTH FACE MASONRY (ORCO BLOCK)

C4. 4X12X12 SQUARE ON SQUARE BREEZE BLOCK

WOOD GRAIN METAL SIDING: (RMP ROLLFAB)
D1. ALUMABOARD HAZELNUT BROWN

METAL ROOF PANELS (MORIN OR EQ.) E1 CUSTOM COLOR TO MATCH PAINT AS & I HOMES,



SCH 2005 SUITE

::: Clayton

2nd Stre East 2nd ottsdale, ON 75 7502 Sc

Revisions

Description Date

DOCUMENTS

DRAWN BY: KS CHECKED BY: KS SUE DATE: 5/1/2019



Exterior Elevations

- MW GRAY

- CHARCOAL

- MW GRAY

A3.2

Revisions

Description Date

STUCCO PANEL SIZE IS 144 SF, WITH A WIDTH TO LENGHT RATIO OF 1:2 1/2. TYPICAL JOINT PLACEMENTSINCLUDE:

AND BALCONIES

CORNERS ONLY.

PAINT ALL EXTERIOR MOUNTED ELECTRICAL AND MECHANICAL PANELS/BOXES TO MATCH ADJACENT SURFACE OF THE BUILDING.

BLDG COLORUNO ALL PAINT COLOR CHANGES TO TERMINATE ON INSIDE CORNERS

PROVIDE 2" OR 4" SOLID CMU CAPS AT ALL EXPOSED CMU SITE

HORIZONTALLY (AT EACH FLOOR), AND VERTICALLY (FROM FLOOR TO FLOOR) AND PAINTED TO MATCH ADJACENT STUCCO COLOR

COLORS

PAINT: (DUNN EDWARDS 'DE') | PAINT: (DUNN EDWARDS DE.)
A1.	MAIN FIELD (LIGHT)	DW314 - DESERT STAR	DW314 - DESERT STAR	DET625 - RECLAIMED WOOD	LRV 47
A2.	2ND FIELD (MEDIUM)	DET625 - METAL FRINGE	LRV 21		
CT546 - OASIS	LRV 24				
CT546 - OA					

C3. 8x8x16 MASONRY (ORCO BLOCK)

2" OFFSET CORE SHADOW BLOCK INTEGRAL COLOR SMOOTH FACE

WOOD GRAIN METAL SIDING: (RMP ROLLFAB)
D1. ALUMABOARD HAZELNUT BROWN

A4. ACCENT (TEAL) DET546 - OASIS A5. ACCENT (ORANGE) DE5229 - CLAY TERRACE - LRV 29

ALUMINUM STOREFRONT: (ARCADIA)

B1. AB-7 'STANDARD DARK BRONZE' ANODIZED

B2. DARK BRONZE ANODIZED


MASONRY (SUPERLITE BLOCK)

C1. 4x8x16 INTEGRAL COLOR SMOOTH FACE C2. 4X10X16 INTEGRAL COLOR SMOOTH FACE MW GRAY - MW GRAY - CHARCOAL

C4. 4X12X12 SQUARE ON SQUARE BREEZE BLOCK - MW GRAY

ReZone2 - Design Review1



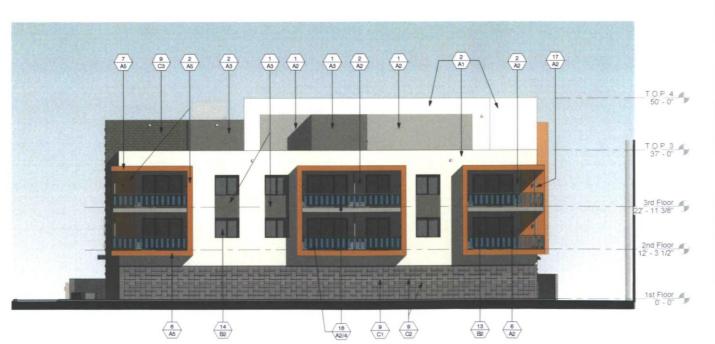

2 East Elevation 3/32" = 1'-0"

11:22:01

SLIDING GLASS DOORS AND WINDOWS: (MILGARD)

STANDING SEAM METAL ROOF

BUILDING SIGNAGE - UNDER SPEARATE PERMIT AND SUBMITTAL

STUCCO OVER PAPER BACKED METAL LATH ON EXT. GRADE

STUCCO OVER METAL LATH AND 1" FOAM ON EXT. GRADE

STUCCO CONTROL JOINT
BALCONY FACIA WITH METAL T-BAR AND STUCCO FINISH

EXPOSED MASONRY - RUNNING BOND, RAKED JOINTS DECORATIVE FENCE BLOCK PANEL - STACKED BOND ALUMINUM STOREFRONT - FACTORY FINISH ALUMINUM STOREFRONT / DOORS - SEE SCHEDULE

ROOF OVERHANG - STUCCO FRONT FACIA AND UNDERSIDE

SLIDING ALUMINUM/GLASS PATIO DOORS - FACTORY FINISH

FIXED/SINGLE SLIDING ALUMINUM WINDOW - FACTORY FINISH HOLLOW METAL DOOR AND FRAME - PAINTED - SEE SCHEDULE

PLYWOOD SHEATHING STUCCO OVER METAL LATH AND1" FOAM OVER CMU

SECTIONAL GARAGE DOOR - FACTORY FINISH

STEEL COLUMN - PAINTED TUBE STEEL RAILING/GUARDRAIL - PAINTED
TUBE STEEL VIEW / POOL FENCE - PAINTED

HORIZONTAL METAL SIDING CMU REFUSE ENCLOSURE

MATERIALS / KEY NOTES

PLYWOOD SHEATHING

CMU SITE/SCREEN WALL WITH STUCCO FINISH

12"W CAST IN PLACE BOARD FORMED CONCRETE SEAT/SITE WALL COLOR AND TEXTURE TO MATCH CLAYTON HOUSE

GUARD WITH GOLD COAT WATER RESISTIVE BARRIER, PER THE FOLLOWING EVALUATION REPORTS: ESR-2323 STO POWERWALL STUCCO SYSTEM ESR-1233 STO GUARD WITH GOLD COAT WATER RESISTIVE BARRIERS - OR APPROVED EQUAL

GENERAL NOTES

STUCCO CONTROL JOINTS SHOWN AT TYPICAL LOCATIONS ONLY.
PROVIDE ADDITIONAL CONTROL JOINTS AS MAY BE REQURIED AND RECCOMENDED BY STUCCO MANUFACTURER VERIFY

STUCCO SYSTEM TO BE 'STO POWERWALL' OVER 1" INSULATION

BOARD, WITH 1.0/FINE INTEGRAL COLORED FINISH TO MATCH PAINT COLOR SPECIFIED. SYSTEM TO BE INSTALLED OVER STO

LOCATION WITH ARCHITECT. STUCCO CONTROL JOINTS TO BE PROVIDED SO THAT MAX.

HORIZONTALLY AT EACH FLOOR LEVEL VERTICALL FROM CORNER OF SLIDING DOORS, WINDOWS

ALL CONTROL JOINTS & REVEALS TO TERMINATE ON INSIDE PROVIDE SEALANT AT ALL STUCCO PENETRATIONS.

PAINT ALL VENTS, FLASHING, MISC. MATERIALS TO MATCH ADJ.

ALL EXPOSED DRYER AND EXHAUST VENTS TO BE ALIGNED 10.

ALL EXPOSED CMU TO BE STACKED OR RUNNING BOND AS SHOWN, WITH RAKED JOINTS, U.N.O.

METAL ROOF PANELS (MORIN OR EQ.) E1. CUSTOM COLOR TO MATCH PAINT A5

DOCUMENTS

JOB NUMBER: 1809 DRAWN BY: KS

HECKED BY: KS SSUE DATE: 5/1/2019

32407 KRISTJAN SIGURDSSON


. Diguida

Exterior Elevations



OVERALL AREA OF FACADE = 11,310 SF

AREA OF ENCROUCHEMENT = 0 SF

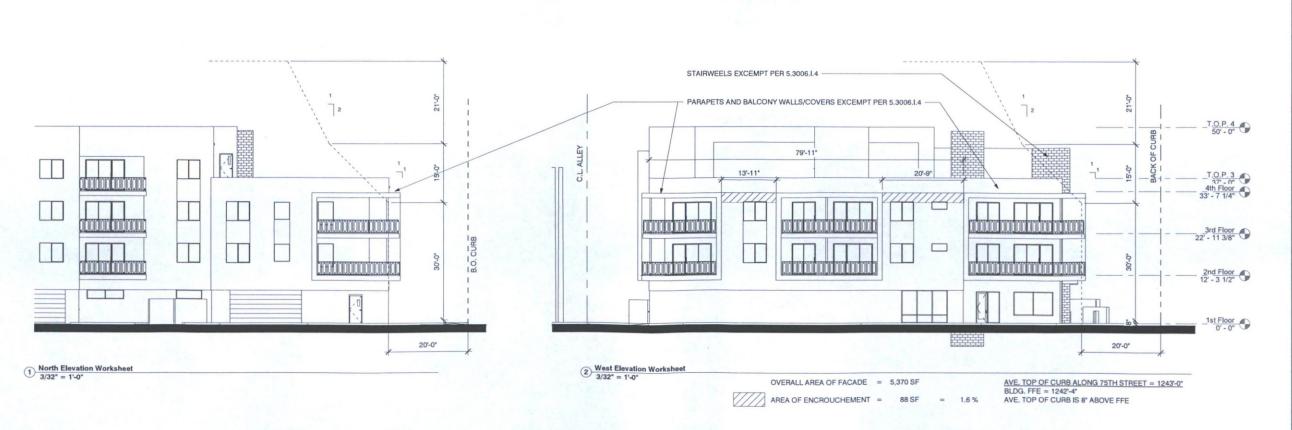

K & I HOMES, LLC



6125 E. INDIAN SCHOOL F SUITE 2005 SCOTTSDALE, AZ 85251 PH: 602-505-2525


:::Clayton

75 on 2nd

OWNERSHIP OF DOCUMENTS

CRAWINGS AND SPECIFICATIONS AS SHOULD BE USED ON OUT-HER PROJECTS OF THE ARCHITECT WHETHER THE PROJECTS OF THE ARCHITECT WHETHER THE PROJECTS OF THE ARCHITECTS OF THE ARC

2-ZN-2019

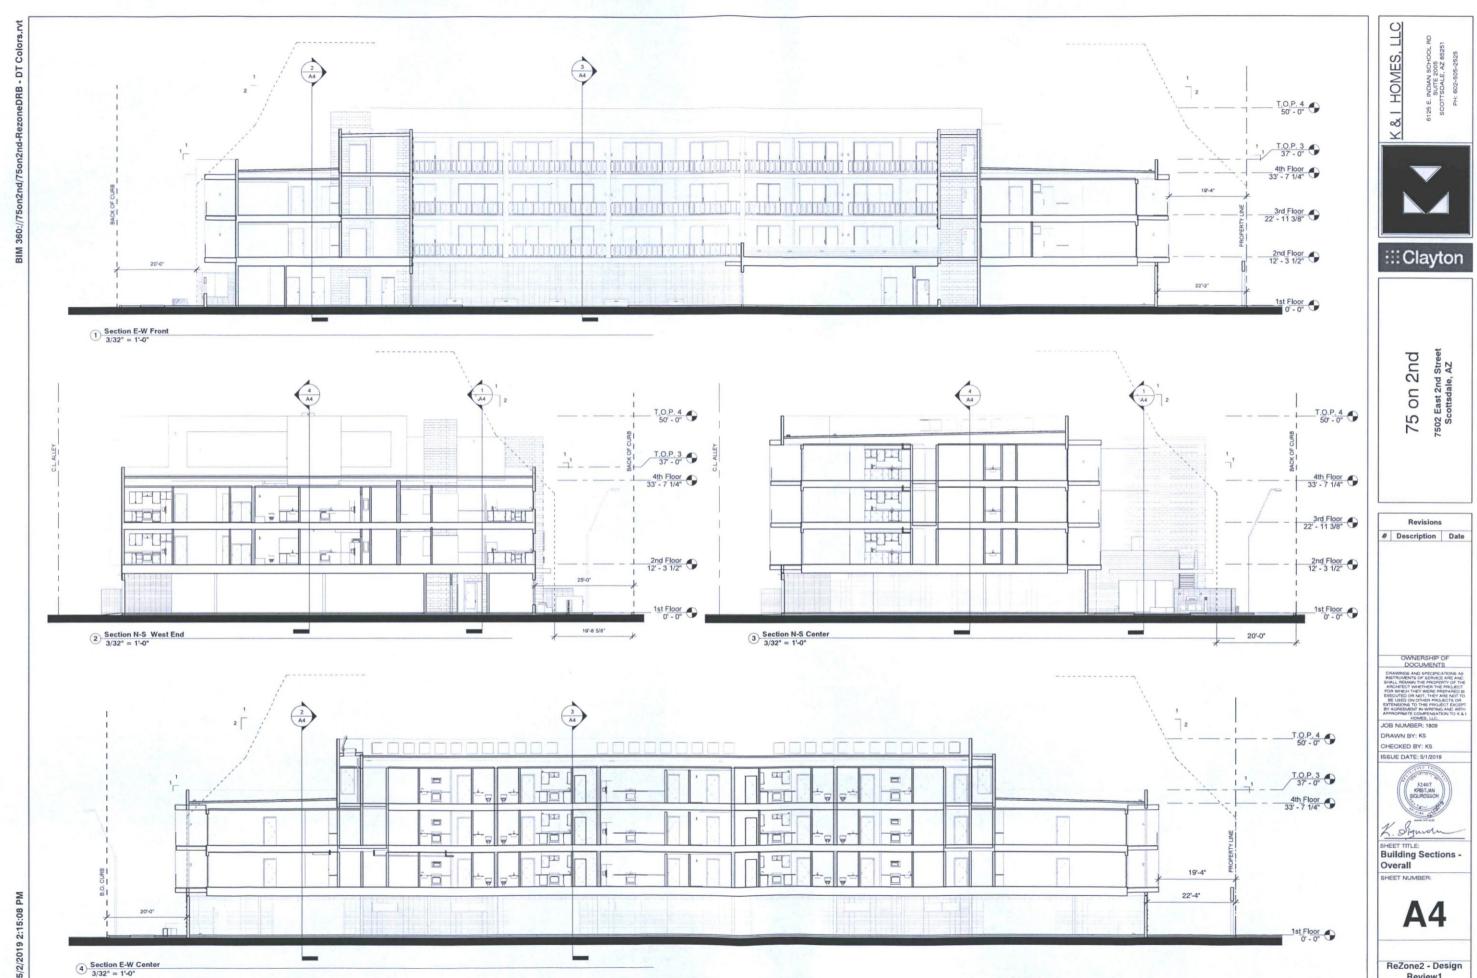



PERSPECTIVE VIEW FROM SOUTHEAST



K & I HOMES, LLC



::: Clayton

75 on 2nd

DRAWN BY: KS


CHECKED BY: KS



A5

ReZone2 - Design Review1

PERSPECTIVE VIEW FROM SOUTHWEST

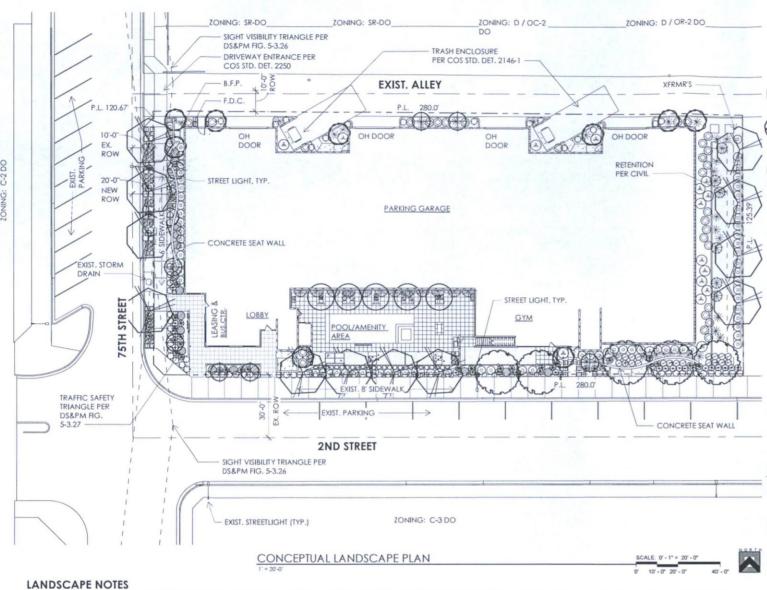

PLANTS, SHALL NOT EXCEED SEVEN (7) FEET IN ANY DIRECTION, PER ZONING ORDINANCE SECTION 10.501.A. 2. ALL TREES SHALL BE FIFTEEN (15) GALLON MINIMUM SIZE, AND A LEAST FIFTY (50) PERCENT SHALL BE MATURE TREES WITH A MINIMUM

1. DECOMPOSED GRANITE OR SIMILAR MATERIAL AROUND THE MATURE FORM OF A SPECIMEN PLANT, TREE CANOPY, OR GROUPS OF

2" CALIPER. 3.

THIS PROJECT CONTAINS NO NEW PARKING / LANDSCAPE AREAS & REQUIREMENTS.

4. ALL PLANT MATERIALS SHALL BE FROM THE ARIZONA DEPARTMENT OF WATER RESOURCE'S (ADWR) PHOENIX ACTIVE MANAGEMENT AREA PLANT LIST & IS EXEMPT FROM THE CITY OF SCOTTSDALE'S ENVIRONMENTALLY SENSITIVE LANDS ORDINANCE (ESLO) PLANT LIST.

5. THIS PROJECT DOES NOT CONTAIN ANY NATURAL AREA OPEN SPACE (NAOS).

6. NO NATIVE PLANT INVENTORY & SALVAGE REQUIRED FOR THIS LOCATION.

7. THORNY SHRUBS AND CACTI SHALL BE PLANTED SO THAT THEIR MATURE SIZE/CANOPY WILL BE AT LEAST 4 FEET AWAY FROM ANY WALKWAYS OR PARKING AREA CURBING. PER DSPM SEC. 2-1.1001.13.

8. ALL SIDEWALKS TO BE A MIN. 6'-0" CLEAR.

9. ALL FIRELANE SURFACES SHALL SUPPORT 83,000 LBS GROSS VEHICULAR WEIGHT PER DS & PM 2-1.802(3)

10. ALL LANDSCAPE AREAS SHALL BE IRRIGATED BY AUTOMATIC UNDERGROUND IRRIGATION SYSTEM.

11. REFER TO CIVIL FOR ALL GRADING, DRAINAGE, RETENTION AREAS, SETBACKS, EASEMENTS & P.U.E. LOCATIONS

	TENTI ELOCITO					
	BOTANICAL NAME	COMMON NAME	CAL. SIZE	BOX SIZE	QTY	COMMENT
	TREE					
0	BAUHINIA LUNARIOIDES	ANACACHO ORCHID TREE	1.25"		6	8'x6'
\oplus	CAESALPINIA MEXICANA	MEXICAN BIRD OF PARADISE	1.5"		10	15'x15'
7	QUERCUS VIRGINIANA	SOUTHERN LIVE OAK	2.5"		13	40'x50'
0	SOPHORA SECUNDIFLORA	TEXAS MOUNTAIN LAUREL	2"		10	15'x15'
)	ULMUS PARVIFOLIA 'EMERALD II' 'EMERALD II'	EVERGREEN ELM 'EMERALD'	1.5"		6	30'x30'
	PALM					
5)	ALOE HERCULES _SHRUBS	TREE ALOE 'HERCULES'		15 Gal.	4	
2	CAESALPINIA PULCHERRIMA	RED BIRD OF PARADISE		5 Gal.	18	
9	CALLIANDRA HYBRID 'SIERRA STARR'	SIERRA STARR CALLIANDRA		5 Gal.	30	
0	EREMOPHILA HYGROPHANA	BLUE BELLS		5 Gal.	4	
)	EUPHORBIA RIGIDA	GOHPER PLANT		5 Gal.	31	
*	HESPERALOE PARVIFLORA	RED YUCCA		5 Gal.	32	
}	MUHLENBERGIA x 'PINK	PINK FLAMINGO MUHLY		5 Gal.	27	4't x 18"w
0	TECOMA STANS HYBRID 'SPARKY' _ACCENT	YELLOW BELLS 'SPARKY'		5 Gal.	73	
X	AGAVE DESMETIANA	SMOOTH AGAVE		5 Gal.	30	
0	ALOE 'BLUE ELF	BLUE ELF ALOE		5 Gal.	58	
2	ALOE BARBARENSIS	MEDICINAL ALOE		5 Gal.	21	
X	DASYLIRION WHEELERI	DESERT SPOON		5 Gal.	7	
0	PEDILANTHUS MACROCARPAGROUNDCOVER	LADY'S SLIPPER		5 Gal.	18	
Ф	PORTULA CARIA AFRA	ELEPHANT'S FOOD		3 Gal.	79	
)	SPHAGNETCOLA TRILOBATAVINES	YELLOW DOT		1 Gal.	87	
N	PODRANEA RICASOLIANA	PINK TRUMPET VINE		15 Gal.	13	

PLANT LEGEND

GROUND PLANE TREATMENT

NON-TURE JANGSCAPE 3/4" MINUS DECOMPOSED GRANITE,

'MADISON GOLD'

3"-8" RIP RAP, 'MADISON GOLD' 2' AROUND ALL CATCH BASIN LOCATIONS (NATURAL PLACEMENT)

SYNTHETIC TURF - ACT GLOBAL "NATURAL 48", INSTALL OVER 4" 1/4" MINUS DECOMPOSED GRANITE

LANDSCAPE CALCULATIONS

+/- 2.470 s.f.
NA
+/- 624 s.f.

+/- 6,725 S.F.

PER CIVIL PLANS

+/-775 S.F.

VICINITY MAP



CC K & I HOMES,



::: Clayton

PIXELstudic

75 on 2nd

Description Date

DOCUMENTS

DRAWN BY: DSS



Landscape Plan

CONCERTIAL LANDSCARE DIAM	SCALE: 0' - 1" = 20' -
CONCEPTUAL LANDSCAPE PLAN	SCALE: 0 - 1 = 20 -
1" = 20'-0"	0' 10'-0" 20'-0"

LANDSCAPE NOTES

- 1. DECOMPOSED GRANITE OR SIMILAR MATERIAL AROUND THE MATURE FORM OF A SPECIMEN PLANT, TREE CANOPY, OR GROUPS OF PLANTS, SHALL NOT EXCEED SEVEN (7) FEET IN ANY DIRECTION, PER ZONING ORDINANCE SECTION 10.501.A.
- 2. ALL TREES SHALL BE FIFTEEN (15) GALLON MINIMUM SIZE, AND A LEAST FIFTY (50) PERCENT SHALL BE MATURE TREES WITH A MINIMUM 2" CALIPER.
- 3. THIS PROJECT CONTAINS NO NEW PARKING / LANDSCAPE AREAS & REQUIREMENTS.
- 4. ALL PLANT MATERIALS SHALL BE FROM THE ARIZONA DEPARTMENT OF WATER RESOURCE'S (ADWR) PHOENIX ACTIVE MANAGEMENT AREA PLANT LIST & IS EXEMPT FROM THE CITY OF SCOTTSDALE'S ENVIRONMENTALLY SENSITIVE LANDS ORDINANCE (ESLO) PLANT LIST.
- 5. THIS PROJECT DOES NOT CONTAIN ANY NATURAL AREA OPEN SPACE (NAOS).
- 6. NO NATIVE PLANT INVENTORY & SALVAGE REQUIRED FOR THIS LOCATION.
- 7. THORNY SHRUBS AND CACTI SHALL BE PLANTED SO THAT THEIR MATURE SIZE/CANOPY WILL BE AT LEAST 4 FEET AWAY FROM ANY WALKWAYS OR PARKING AREA CURBING. PER DSPM SEC. 2-1.1001.13.
- 8. ALL SIDEWALKS TO BE A MIN. 6'-0" CLEAR.
- 9. ALL FIRELANE SURFACES SHALL SUPPORT 83,000 LBS GROSS VEHICULAR WEIGHT PER DS & PM 2-1.802(3)
- 10. ALL LANDSCAPE AREAS SHALL BE IRRIGATED BY AUTOMATIC UNDERGROUND IRRIGATION SYSTEM.
- 11. REFER TO CIVIL FOR ALL GRADING, DRAINAGE, RETENTION AREAS, SETBACKS, EASEMENTS & P.U.E. LOCATIONS

	PLANT LEGEND						
	BOTANICAL NAME	COMMON NAME	CAL. SIZE	BOX SIZE	QTY	COMMENTS	
	TREE						
\odot	BAUHINIA LUNARIOIDES	ANACACHO ORCHID TREE	1.25"		6	8'x6'	
0	CAESALPINIA MEXICANA	MEXICAN BIRD OF PARADISE	1.5"		10	15'x15'	
13	QUERCUS VIRGINIANA	SOUTHERN LIVE OAK	2.5"		13	40'x50'	
40	SOPHORA SECUNDIFLORA	TEXAS MOUNTAIN LAUREL	2"		10	15'x15'	
0	ULMUS PARVIFOLIA 'EMERALD II' 'EMERALD II'	EVERGREEN ELM 'EMERALD'	1.5"		6	30'x30'	
	PALM						
(+	ALOE HERCULES .SHRUBS	TREE ALOE 'HERCULES'		15 Gal.	4		
(2)	CAESALPINIA PULCHERRIMA	RED BIRD OF PARADISE		5 Gal.	18		
\bigcirc	Calliandra hybrid 'Sierra Starr'	SIERRA STARR CALLIANDRA		5 Gal.	30		
\otimes	EREMOPHILA HYGROPHANA	BLUE BELLS		5 Gal.	4		
\odot	EUPHORBIA RIGIDA	GOHPER PLANT		5 Gal.	31		
*	HESPERALOE PARVIFLORA	RED YUCCA		5 Gal.	32		
0	MUHLENBERGIA x 'PINK	PINK FLAMINGO MUHLY		5 Gal.	27	4't x 18"w	
0	TECOMA STANS HYBRID 'SPARKY' _ACCENT	YELLOW BELLS 'SPARKY'		5 Gal.	73		
*	AGAVE DESMETIANA	SMOOTH AGAVE		5 Gal.	30		
0	ALOE 'BLUE ELF	BLUE ELF ALOE		5 Gal.	58		
0	ALOE BARBARENSIS	MEDICINAL ALOE		5 Gal.	21		
*	DASYLIRION WHEELERI	DESERT SPOON		5 Gal.	7		
0	PEDILANTHUS MACROCARPAGROUNDCOVER	LADY'S SLIPPER		5 Gal.	18		
Ф	PORTULACARIA AFRA	ELEPHANT'S FOOD		3 Gal.	79		
\bigcirc	SPHAGNETCOLA TRILOBATAVINES	YELLOW DOT		1 Gal.	87		
	PODRANEA RICASOLIANA	PINK TRUMPET VINE		15 Gal.	13		

GROUND PLANE TREATMENT

NON-TURY JANDSCAPE 3/4" MINUS DECOMPOSED GRANITE, 'MADISON GOLD'

3"-8" RIP RAP, 'MADISON GOLD' 2' AROUND ALL CATCH BASIN LOCATIONS (NATURAL PLACEMENT)

SYNTHETIC TURF - ACT GLOBAL "NATURAL 48", INSTALL OVER 4" 1/4" MINUS DECOMPOSED GRANITE

LANDSCAPE CALCULATIONS

LANDSCAPE OPEN SPACE	+/- 2.470 s.f.
PARKING LANDSCAPE	NA
FRONTAGE LANDSCAPE	+/- 624 s.f.

+/- 6,725 S.F.

PER CIVIL PLANS

+/- 775 S.F.

VICINITY MAP



INDIAN SCHO SUITE 2005 TSDALE, AZ 8

& I HOMES,



Clayton

2nd on 75

Revisions # Description Date

JOB NUMBER: 19-00-DRAWN BY: DSS CHECKED BY: DSS



Landscape Plan



ReZone2 - Design